

# ACTIVITY DETERMINATION

Project No. BGV9A

## Conflict of Interest<sup>1</sup>

In this matter:

1. I have declared any possible conflict of interests (real, potential or perceived) to the Chief Executive, Land & Housing Corporation.
2. I do not consider I have any personal interests that would affect my professional judgement.
3. I will inform the Chief Executive, Land & Housing Corporation as soon as I become aware of a possible conflict of interest.

Signed.....

Name..... Emma Nicholson

Dated..... 8 March 2023

Having regard to the Determination Recommendation Report, the Statement of Compliance and the Review of Environmental Factors for this project addressing matters under Part 5 of the *Environmental Planning and Assessment Act 1979*, I determine that the activity proceed as described below and subject to the identified requirements set out in **Schedule 1**.

## SITE IDENTIFICATION

### STREET ADDRESS

Unit/Street No

47-49

Street or property name

Curry Street

Suburb, town or locality

Wallsend

Postcode

2287

Local Government Area(s)

City of Newcastle

Real property description (Lot and DP)

Lots 141 and 142 in DP 35087

## ACTIVITY DESCRIPTION

Provide a description of the activity

Demolition of 2 existing dwellings and associated structures, and the construction of a residential flat building containing 4 x 1-bedroom and 5 x 2-bedroom dwellings, with associated landscaping and fencing, surface car parking for 5 cars and consolidation into a single lot.

<sup>1</sup> Conflict of interest includes actual and potential. A conflict of interest includes pecuniary i.e. financial interests to you or a related party or non-pecuniary i.e. benefits to relatives, friends, business associates and personal causes, etc. This includes "related persons" as defined in the Property, Stock and Business Agency Act 2002.

Signed.....

Dated..... 8 March 2023

Emma Nicholson  
Acting Head of Policy and Innovation  
Land and Housing Corporation

## SCHEDULE 1

### IDENTIFIED REQUIREMENTS

#### PART A – Standard Identified Requirements

#### THE DEVELOPMENT

*The following identified requirements are to ensure that the **residential** activity is carried out in accordance with the plans / documents and any amendments arising from the Review of Environmental Factors under Part 5 of the Environmental Planning & Assessment Act 1979, Section 171 of the Environmental Planning and Assessment Regulation 2021 and the requirements of State Environmental Planning Policy (Housing) 2021*

1. The development shall be carried out substantially in accordance with the following plans / documents and as modified below by any of the undermentioned Identified Requirements:

Title / Name:	Drawing No / Document Ref.:	Revision / Issue:	Date [dd.mm.yyyy]:	Prepared by:
Architectural Plans				
Cover Sheet	Drawing No. 000	P3	12.04.2022	Sam Crawford Architects
Block Analysis Plan	Drawing No. 101	P3	12.04.2022	
Site Analysis Plan	Drawing No. 102	P3	12.04.2022	
Demolition Plan	Drawing No. 103	P3	12.04.2022	
Development Data	Drawing No. 104	P3	12.04.2022	
Site Plan	Drawing No. 105	01	12.04.2022	
Ground Floor Plan	Drawing No. 106	P3	12.04.2022	
First Floor Plan	Drawing No. 107	P3	12.04.2022	
Roof Plan	Drawing No. 108	P3	12.04.2022	
Liveable Housing Compliance	Drawing No. 109	P3	12.04.2022	
Street Elevations	Drawing No. 201	P3	12.04.2022	
Elevations	Drawing No. 202	P3	12.04.2022	
Sections	Drawing No. 301	P3	12.04.2022	
Shadow Diagrams	Drawing No. 401	P3	12.04.2022	
Solar Access	Drawing No. 402	P3	12.04.2022	
External Finishes and Materials	Drawing No. 501	P3	12.04.2022	
Civils Plans				
Cover Sheet , Locality Plan & Schedule of Drawings	80822047-CI-0001	5	28.11.2022	Cardno (NSW/ACT) Pty Ltd
Civil Construction Notes	80822047-CI-0002	5	28.11.2022	
Stormwater Drainage Plan Ground Floor	80822047-CI-1101	6	28.11.2022	
Cut & Fill Plan	88022047-CI-1102	3	28.11.2022	
Bulk Earthworks Level	88022047-CI-1103	3	28.11.2022	



Title / Name:	Drawing No / Document Ref.:	Revision / Issue:	Date [dd.mm.yyyy]:	Prepared by:
Sedimentation & Erosion Control Plan	88022047-CI-1201	6	28.11.2022	
Stormwater Details Sheet 1	80822047-CI-2101	5	28.11.2022	
Stormwater Details Sheet 2	80822047-CI-2102	5	28.11.2022	
Stormwater Details Sheet 3 – OSD Rainwater Tank Details	80822047-CI-2103	5	28.11.2022	
Sedimentation and Erosion Control Details	80822047-CI-2201	5	28.11.2022	
Landscape Plans				
Landscape Extent of Works	Page 3	05	23.06.2022	Place Design Group
Landscape Plan	Page 4	05	23.06.2022	
Fencing Strategy	Page 5	05	23.06.2022	
Landscape Key Plan and Section	Page 6	05	23.06.2022	
Planting Schedule	Page 7	05	23.06.2022	
Material Selection	Page 8	05	23.06.2022	
Typical Landscape Details	Page 9	05	23.06.2022	
Certificates				
BASIX	1277603M_02	-	28.06.2022	Northrop Consulting Engineers Pty Ltd
NatHERS	0007825770	-	28.06.2022	
Reports				
Arborists Stage A Report	-	-	27.10.2021	Hunter Horticultural Services
Traffic Impact Assessment	-	-	13.04.2022	Transport Planning Partnership
Access Review	-	-	28.06.2022	Morris Goding Access Consulting
Design Compliance Assessment	-	-	28.06.2022	BCA Vision
Site Investigation Report	-	-	26.11.2018	STS GeoEnvironmental

- All building work is to be undertaken in accordance with the National Construction Code and referenced Australian Standards.
- All commitments listed in the BASIX certificate and stamped plans shall be implemented.
- All construction documentation and building work are to be certified in accordance with Section 6.28 of the *Environmental Planning and Assessment Act 1979*.
- The land the subject of this determination shall be consolidated into a single lot. The plan of consolidation shall be lodged at the NSW Land Registry Services and shall be registered prior to the occupation of the development. A copy of the registered plan shall be provided to the Land & Housing Corporation.

## OPERATIONAL MATTERS

*The following identified requirements relate to the use of the site and are to ensure that the activity and its operation do not interfere with the amenity of the surrounding area.*

## **Stormwater Run-off**

6. Stormwater shall be collected within the site and conveyed in a pipeline to the appropriate gutter or drain under the control of the Council for the area, substantially in accordance with the approved concept stormwater drainage plans.
7. Alterations to the natural surface contours or surface absorption characteristics of the site shall not impede, increase or divert natural surface water runoff so as to cause a nuisance to adjoining property owners.
8. All driveways shall be graded in such a manner as to provide continuous surface drainage flow paths to the appropriate points of discharge.
9. To prevent water from entering buildings, surface waters shall be collected and diverted clear of the buildings by a sub-surface / surface drainage system.

## **Vehicular Access & Parking**

10. A concrete vehicular crossing(s) and layback(s) shall be provided at the entrance(s) / exit(s) to the property. The crossing(s) and layback(s) shall be constructed in accordance with the Council for the area's standard requirements for residential crossings. Council shall be provided with plans for the crossing(s) and layback(s) together with the payment of any Council inspection fees.
11. Particular care shall be taken in the location of vehicular crossings and/or laybacks to avoid poles, pits etc. The cost of any necessary adjustments to utility mains and services associated with the construction of the layback(s) / driveway(s) shall be borne by the Land & Housing Corporation. Obsolete gutter layback(s) shall be constructed as kerb in accordance with the Council's standards.

***Note:** It is recommended that discussions be held with the relevant authorities before construction works commence.*

12. Car parking spaces and driveway(s) shall be constructed of concrete or other approved hard surface materials. The car parking spaces must be clear of obstructions and columns, permanently line marked and provided with adequate manoeuvring facilities. The design of these spaces must comply with AS 2890.1.

## **Site Works**

13. All soil erosion and sediment control measures required to be put in place prior to the commencement of demolition / construction works shall be maintained during the entire period of the works and until all the disturbed areas are restored by turfing, paving or revegetation. Soil erosion and sediment control measures shall be designed in accordance with the guidelines set out in the Blue Book *Managing Urban Stormwater: Soils and Construction* (4th edition, Landcom, 2004).
14. An appropriately qualified person shall design any retaining walls or other methods necessary to prevent the movement of excavated or filled ground, including associated stormwater drainage measures.

## **Building Siting**

15. All buildings shall be sited well clear of any easements affecting the site. The builder shall ascertain if any easements do exist and, and if they do, obtain full details of such prior to construction commencing.

### **Smoke Detection System(s)**

16. Smoke detection systems shall be installed throughout the building(s) in accordance with requirements of Clause E2.2a of the Building Code of Australia. Detectors and alarms shall comply with AS 3786 and AS 1670 and must be:
- i. connected to a permanent 240V power supply, and
  - ii. provided with a battery backup to activate the alarm unit in the event of failure of the permanent power supply.

### **Site Soil Contamination**

17. If the site is identified as being potentially affected by soil contamination, it shall be inspected by a suitably qualified person to identify any contaminated or hazardous material present. A proposal for remediation shall be prepared, which may include preparation of a Remedial Action Plan, and remediation shall be carried out in accordance with the proposal. A Validation Report, prepared in accordance with Environment Protection Authority requirements, shall be obtained from a qualified expert on completion of the remediation work to verify that the site is suitable for the intended residential use. A copy of the Validation Report shall be provided to the Land & Housing Corporation on completion of the remediation works.

### **Landscaping**

18. Landscaping shall be carried out substantially in accordance with the approved landscape plan(s), as modified by the identified requirements, and maintained for a period of 12 months by the building contractor. The Council for the area shall be consulted in relation to the planting of any street trees.
19. All scheduled plant stock shall be pre-ordered prior to commencement of construction or 3 months prior to the commencement of landscape construction works, whichever occurs sooner, for the supply to the site on time for installation. The builder shall provide written confirmation of the order to Council and provide a copy to the Land & Housing Corporation.

### **Tree Removal**

20. Removal of trees within the boundaries of the site is to be carried out in accordance with the trees shown for removal on the approved landscape plan and Arborist report and no other trees shall be removed without further approval(s).

### **Fencing**

21. All front fencing and gates shall be constructed wholly within the boundaries of the site. Any gates associated with the fencing shall swing inwards towards the site.

### **Provision of Letterbox Facilities**

22. Suitable letterbox facilities shall be provided in accordance with Australia Post specifications.

### **Public Liability Insurance**

23. A valid public liability insurance policy of at least \$10M shall be maintained throughout the demolition / construction works by the building contractor.

## **PRIOR TO ANY CONSTRUCTION WORK COMMENCING ON THE SITE**

*The following identified requirements are to be complied with prior to any work commencing on the site.*

### **Service Authority Clearances**

24. A compliance certificate, or other evidence, shall be obtained from the relevant water utility provider (e.g. the local Council for the area, Hunter Water or Sydney Water), confirming service availability prior to work commencing.

**Note:**

*Payment of water and/or sewer service charges and/or a notice of requirements for works to be carried out during construction / prior to occupation may be applicable prior to issue of the compliance certificate.*

25. A written clearance from an electricity supply authority stating that electrical services are available to the site, or that arrangements have been entered into for the provision of services to the site, shall be obtained prior to work commencing.
26. A certificate from an approved telecommunications carrier certifying that satisfactory arrangements have been made for the provision of underground telephone services, to the site and to each dwelling, shall be obtained prior to work commencing.
27. Where the site is to be connected to reticulated gas, a certificate from an approved gas carrier certifying that satisfactory arrangements have been made for the provision of underground gas services, to the site and to each dwelling, shall be obtained prior to work commencing.

### **Stormwater Disposal**

28. A detailed stormwater drainage plan(s), substantially in accordance with the approved concept stormwater drainage plan(s), shall be prepared and submitted to the Land & Housing Corporation. Any on-site detention system shall be designed in accordance with the relevant catchment authority's requirements (e.g. the Upper Parramatta River Catchment Trust On-site Detention Handbook) and/ or the Council for the area's drainage code.

## **PRIOR TO ANY WORK COMMENCING ON THE SITE**

### **Utilities Service Provider Notification**

29. The demolition / construction plans shall be submitted to the appropriate water utility's office (e.g. Sydney Water office) to determine whether or not the development will affect the utility's sewer and water mains, stormwater drains and any easements.

**Note:**

*If the development complies with water utility's requirements, the plans will be stamped indicating that no further requirements are necessary.*

### **Disconnection of Services**

30. All services that are required to be disconnected shall be appropriately disconnected and made safe prior to commencement of the demolition / construction works. The various service authorities shall be consulted regarding their requirements for the disconnection of services.

31. All existing services within the boundary to remain live shall be identified, pegged and made safe.

### **Demolition**

32. The builder shall notify the occupants of premises on either side, opposite and at the rear of the site a minimum of five (5) working days prior to demolition. Such notification shall be clearly written on an A4 size paper giving the date demolition will commence and be placed in the letterbox of every premise (including every unit in a multi-unit residential building or mixed use building). The demolition shall not commence prior to the date that is stated in the notice letter.
33. Prior to the demolition, a Work Plan shall be prepared by a competent person(s) in accordance with AS 2601 and shall be submitted to the Land & Housing Corporation. The Work Plan shall outline the identification of any hazardous materials (including surfaces coated with lead paint), method of demolition, the precautions to be employed to minimise any dust nuisance and the disposal methods for hazardous materials.
34. If buildings to be demolished are determined as, or suspected of, containing asbestos cement, a standard commercially manufactured sign containing the words 'DANGER ASBESTOS REMOVAL IN PROGRESS', and measuring not less than 400mm x 300mm, shall be erected in a prominent visible position on the site for the duration of the demolition works.

**Note:**

*Any buildings constructed before 1987 is assumed to contain asbestos.*

### **Council Notification**

35. The Council for the area shall be advised by the building contractor in writing, of the date it is intended to commence work, including demolition. A minimum period of five (5) working days notification shall be given.

### **Landfill**

36. Where site filling is required, a minimum of 95% standard compacting shall be achieved and certified by a NATA registered Soils Laboratory.
37. Land fill materials must satisfy the following requirements:
- i. Shall be Virgin Excavated Natural Matter (VENM),
  - ii. Shall be free of slag and hazardous, contaminated, putrescible, toxic or radioactive matter, and
  - iii. Shall be free of industrial waste and building debris.

### **Site Facilities**

38. The following facilities shall be installed on the site:
- (a) Toilet facilities shall be provided at the rate of 1 toilet for every 20 persons, or part thereof, employed at the site. Each toilet shall be a standard flushing toilet and shall be connected to a public sewer. If connection to a public sewer is not practicable, to an accredited sewerage management facility provided by the Council for the area or if this is also not practicable to some other council approved management facility.

- (b) Adequate refuse disposal methods and builders storage facilities. Builders' wastes, materials or sheds shall not be placed on any property other than that to which this activity relates.
39. Access to the site shall only be provided via an all weather driveway on the property and shall not be provided from any other site.

### Site Safety

40. A sign shall be erected in a prominent position on the site:
- (a) showing the name, address and telephone number of the responsible Land & Housing Corporation officer for the work, and
  - (b) showing the name of the principal contractor (if any) and the telephone number on which that person may be contacted during and outside working hours, and
  - (c) stating that unauthorised entry to the site is prohibited.

The sign shall be maintained while the work is being carried out but shall be removed when the work has been completed.

**Note:**

*This requirement does not apply in relation to building work that is carried out inside an existing building that does not affect the external walls of the building.*

41. A minimum 1.8m high security fence or Class A / Class B (overhead) hoarding must be erected between the work site and any public place prior to demolition / construction. Access to the site shall be restricted to authorised persons only and the site shall be secured against unauthorised entry when demolition / construction work is not in progress or the site is otherwise unoccupied.

**Note:**

*Approval from the relevant roads authority may be required under Section 138 of the Roads Act 1993 where a Class A or B hoarding encroaches onto the footpath of / or a public thoroughfare within a classified road.*

42. Building and demolition materials shall not be stored external to the site (i.e. footpath or roadway).

### Protection of Trees

43. Trees and other vegetation that are to be retained on site shall be protected prior to the commencement of works and for the duration of the construction period in accordance with the details provided in the Arborist report.

### Waste Management

44. A final Waste Management Plan shall be prepared and submitted to the Land & Housing Corporation by the building contractor prior to the commencement of demolition / construction. The Plan shall detail the amount of waste material and the destination of all materials, recyclable and non-recyclable.

## DURING DEMOLITION / CONSTRUCTION

*The following identified requirements are to be complied with whilst works are occurring on the site.*

### Heritage

45. Historic and indigenous archaeological sites and relics are protected under the *Heritage Act 1977* and *National Parks and Wildlife Act 1974*, respectively. Should any relics be uncovered during the course of the approved works, work must cease immediately in the affected area. Subsequently, in cases where historical items or Indigenous items have been uncovered, the Department of Planning and Environment must be contacted.
46. All workers / contractors on the site shall be informed of their obligations, under the *Heritage Act* and *National Parks and Wildlife Act 1974*, that it is illegal to disturb, damage or destroy a relic without the prior approval of the Environment and Heritage, Coordinator-General of the Department of Planning and Environment.

### Demolition

47. Any existing structures identified for demolition shall be demolished prior to commencement of the construction of the activity.
48. Demolition shall be carried out in accordance with the appropriate provisions of AS 2601.
49. Where materials containing asbestos are to be removed, demolition shall be carried out by a licensed contractor(s) that has a current SafeWork NSW accreditation in asbestos removal.
50. Removal of asbestos-based thermal, or acoustic insulation such as sprayed asbestos and asbestos-based lagging and including friable asbestos boards, shall be carried out in accordance with the National Occupational Health and Safety Commission's Code of Practice for the Safe Removal of Asbestos, 2<sup>nd</sup> Edition [NOHSC:2002 (2005)].
51. Hazardous and intractable waste, including all asbestos laden waste arising from the demolition process shall be removed and disposed of in accordance with the requirements of SafeWork NSW and the Department of Planning and Environment.
52. Documentary evidence, in the form of tip receipts from an approved Waste Management Facility, shall be obtained by the demolition contractor and submitted to the Land & Housing Corporation demonstrating the appropriate disposal of the asbestos waste.
53. Demolition procedures shall maximise the reuse and recycling of demolished materials in order to reduce the environmental impacts of waste disposal.
54. During demolition, the public footpath and the public road shall not be obstructed by any vehicles. The public road and footpath shall be swept (not hosed) clean of any material, including clay, soil and sand.
55. All vehicles leaving the site with demolition materials shall have their loads covered and vehicles shall not track soil and other material onto the public roads and footpaths. The footpath shall be suitably protected against damage when plant and vehicles access the site. All loading of vehicles with demolished materials shall occur on site.

## **Survey Reports**

56. Survey reports shall be submitted by the building contractor to the Land & Housing Corporation prior to the placement of the footings / slab and on completion of the dwellings to verify the correct position of the structures in relation to the allotment boundaries.

## **Hours of Demolition / Construction / Civil Work**

57. Demolition / construction / civil work shall only occur on the site between the hours of 7.00am to 5.00pm Monday to Saturday, with no work permitted on Sundays or public holidays.

## **Excavation & Backfilling**

58. All excavations and backfilling associated with the demolition or erection of building(s) shall be executed safely and in accordance with appropriate professional standards. All such work shall be guarded and protected to prevent it from being dangerous to life or property.

## **Pollution Control**

59. Any noise generated during the carrying out of the activity shall not exceed the limits specified in the July 2009 Interim Construction Noise Guidelines published by the former Department of Environment and Climate Change.
60. No fires shall be lit, or waste materials burnt, on the site.
61. No washing of concrete forms or trucks shall occur on the site.
62. Any contamination / spills on the site during construction works shall be actively managed and reported immediately to the appropriate regulatory authorities to minimise any potential damage to the environment.
63. Dust generation during demolition / construction shall be controlled using regular control measures such as on site watering or damp cloth fences.
64. All vehicles transporting loose materials and travelling on public roads shall be secured (i.e. closed tail gate and covered) to minimise dust generation.
65. Non-recyclable waste and containers shall be regularly collected and disposed of at a licensed landfill or other disposal site in accordance with details set out in the final Waste Management Plan.

## **Impact of Construction Works**

66. The Land & Housing Corporation shall bear the cost of any necessary adjustments to utility mains and services.
67. Care shall be taken to prevent any damage to adjoining properties. The building contractor shall be liable to pay compensation to any adjoining owner if, due to demolition/construction works, damage is caused to such adjoining property.



## **PRIOR TO OCCUPATION OF THE DEVELOPMENT**

*The following identified requirements are to be complied with prior to the occupation of the development.*

### **General**

- 68.** The occupation of the development shall not commence until all the identified requirements of this determination have been complied with.

### **Termite Protection**

- 69.** To protect buildings from subterranean termite, termite barriers installed in accordance with AS 3660.1, shall be placed on the underside and in penetrations of the concrete slab floor.

In addition, a durable notice must be permanently fixed inside the meter box indicating:

- (a) the method of protection,
- (b) the date of installation of the system.
- (c) where a chemical barrier is used, its life expectancy as listed on the National Registration Authority label, and
- (d) the need to maintain and inspect the system on a regular basis.

### **Council Infrastructure Damage**

- 70.** The cost of repairing any damage caused to the Council for the area's assets in the vicinity of the site as a result of demolition / construction works shall be met in full by the building contractor.

### **Stormwater Drainage**

- 71.** Prior to occupation, a Work As Executed Plan shall be prepared by the building contractor clearly showing all aspects of the constructed stormwater drainage system, including any on-site detention system. The plan shall demonstrate general compliance with the approved concept stormwater drainage plan(s) and shall include:

- sufficient levels and dimensions to verify the constructed storage volumes, and
- location and surface levels of all pits, and
- invert levels of the internal drainage lines, orifice plates fitted and levels within the outlet control pits, and
- finished floor levels of all structures, and
- verification that any required trash screens have been installed, and
- locations and levels of any overland flow paths, and
- verification that any drainage lines are located wholly within easements, where applicable.

The Work-As-Executed Plan information shall be shown on the final civil works drawings.

A positive covenant and restriction-as-to-user shall be placed over the onsite detention system in accordance with the Council for the area's on-site detention policy to ensure that the system will be adequately maintained. The positive covenant and restriction-as-to-user shall be registered at NSW Land Registry Services prior to occupation. A copy of the registered restriction-as-to-user shall be provided to the Land & Housing Corporation and the Council for the area.

## **PART B – Additional Identified Requirements**

### **Site Specific Requirements**

72. Nil requirements.

### **Requirements Resulting from Council Comments**

73. **Engineering Certification** – Certification from a suitably qualified engineer that excavations for the proposed below-ground OSD and rainwater retention tank will not adversely affect building foundations in close proximity (closer than six metres) of the tank.
74. **Street Trees** – Two trees are to be planted within the road reserve at the front of the site. Tree selection is to be undertaken in consultation with the City of Newcastle Council's (CN) City Greening Team.
75. **Public Domain Works** – The following works in connection with the proposed development, within the Curry Street public road reserve, adjacent to the site, to be designed and constructed by the Land & Housing Corporation and at no cost to CN and in accordance with CN's guidelines and design specifications:
- a) A new driveway crossing in accordance with CN's Standard Drawing A1300.
  - b) Construct a new kerb inlet pit in Curry Street in accordance with CN specification A2201.
  - c) Connect a new kerb inlet pit to existing kerb inlet pit (SW0027973) via approximate 49m of 375mm diameter reinforced concrete pipe at a minimum grade of 1%.
  - d) Associated road pavement, and kerb and gutter replacement.
  - e) Removal of redundant driveways and reinstate kerb and gutter.
  - f) Associated drainage works.

Prior to the commencement of construction, CN will be provided with a copy of plans for the crossing and lay back together. Works are to be certified by the Land & Housing Corporation.

The works are to be completed prior to occupation of the proposed development.

76. **Vehicular Crossing** – to be constructed across the road reserve, in accordance with the following criteria:
- a) Constructed in accordance with CN's A1300 – Driveway Crossings Standard Design Details.
  - b) The driveway crossing, within the road reserve, shall be a maximum of 5.5 metres wide.
  - c) Letterboxes, landscaping and any other obstructions to visibility should be kept clear of or limited in height to 1.2 metres, in the 2 metres by 2.5 metre splay within the property boundary each side of the driveway entrance.
  - d) The proposed driveway shall be a minimum of three metres clear of the trunk of any tree within the public reserve, unless otherwise approved by CN's City Greening Team.
  - e) The proposed driveway shall be a minimum of 750mm clear of the centre of any pole or obstruction within the public reserve and 1 metre clear of any drainage pit.

- f) Any redundant existing vehicular crossing is to be removed at no cost to CN. The road reserve and kerb being restored to match the existing infrastructure.

The works are to be completed prior to the occupation of the proposed development.

- 77. House Numbering** – The premises are to be identified by the provision of house and street numbers on the building exterior and mailbox, respectively, such that they are clearly visible from the road frontage.

The minimum numeral heights are to be:

- a) Exterior of the building = 75mm, and
- b) Group mailbox:
  - street number = 150mm
  - house number = 50mm

House numbering to be in accordance with the following schedule:

ADDRESS SCHEDULE				
Unit/ Dwelling/ Lot Number on plan	Council Allocated Street Addresses			
	House Number	Street Name	Street Type	Suburb
Primary Site Address	47	Curry	Street	Wallsend
Proposed Unit 1	4/47	Curry	Street	Wallsend
Proposed Unit 2	2/47	Curry	Street	Wallsend
Proposed Unit 3	1/47	Curry	Street	Wallsend
Proposed Unit 4	5/47	Curry	Street	Wallsend
Proposed Unit 5	3/47	Curry	Street	Wallsend
Proposed Unit 6	104/47	Curry	Street	Wallsend
Proposed Unit 7	102/47	Curry	Street	Wallsend
Proposed Unit 8	101/47	Curry	Street	Wallsend
Proposed Unit 9	103/47	Curry	Street	Wallsend

- 78. Landscape Plans** – to be amended to be consistent with the Architectural Plans and a copy provided to the Land & Housing Corporation.

#### Requirements as Requested by Public Authorities other than Councils

- 79.** Nil requirements.

#### Requirements Resulting from Adjoining Occupier Comments

- 80. Landscape Plans** – delete 8 x *Elaeocarpus Eumundi* at the eastern boundary. The proposed *Syzygium Australe* at the eastern boundary are to be a minimum 1m in height at the time of planting.

#### Specific Service / Utility Agency Requirements

- 81.** Nil requirements

#### ADVISORY NOTES


- i. Approval of this development activity does not imply or infer compliance with Section 23 of the Disability Discrimination Act 1992. Refer to AS 1428.1 and the Building Code of Australia for detailed guidance.

- ii. Information regarding the location of underground services may be obtained from Dial Before You Dig at [www.1100.com.au](http://www.1100.com.au) or by dialling 1100.








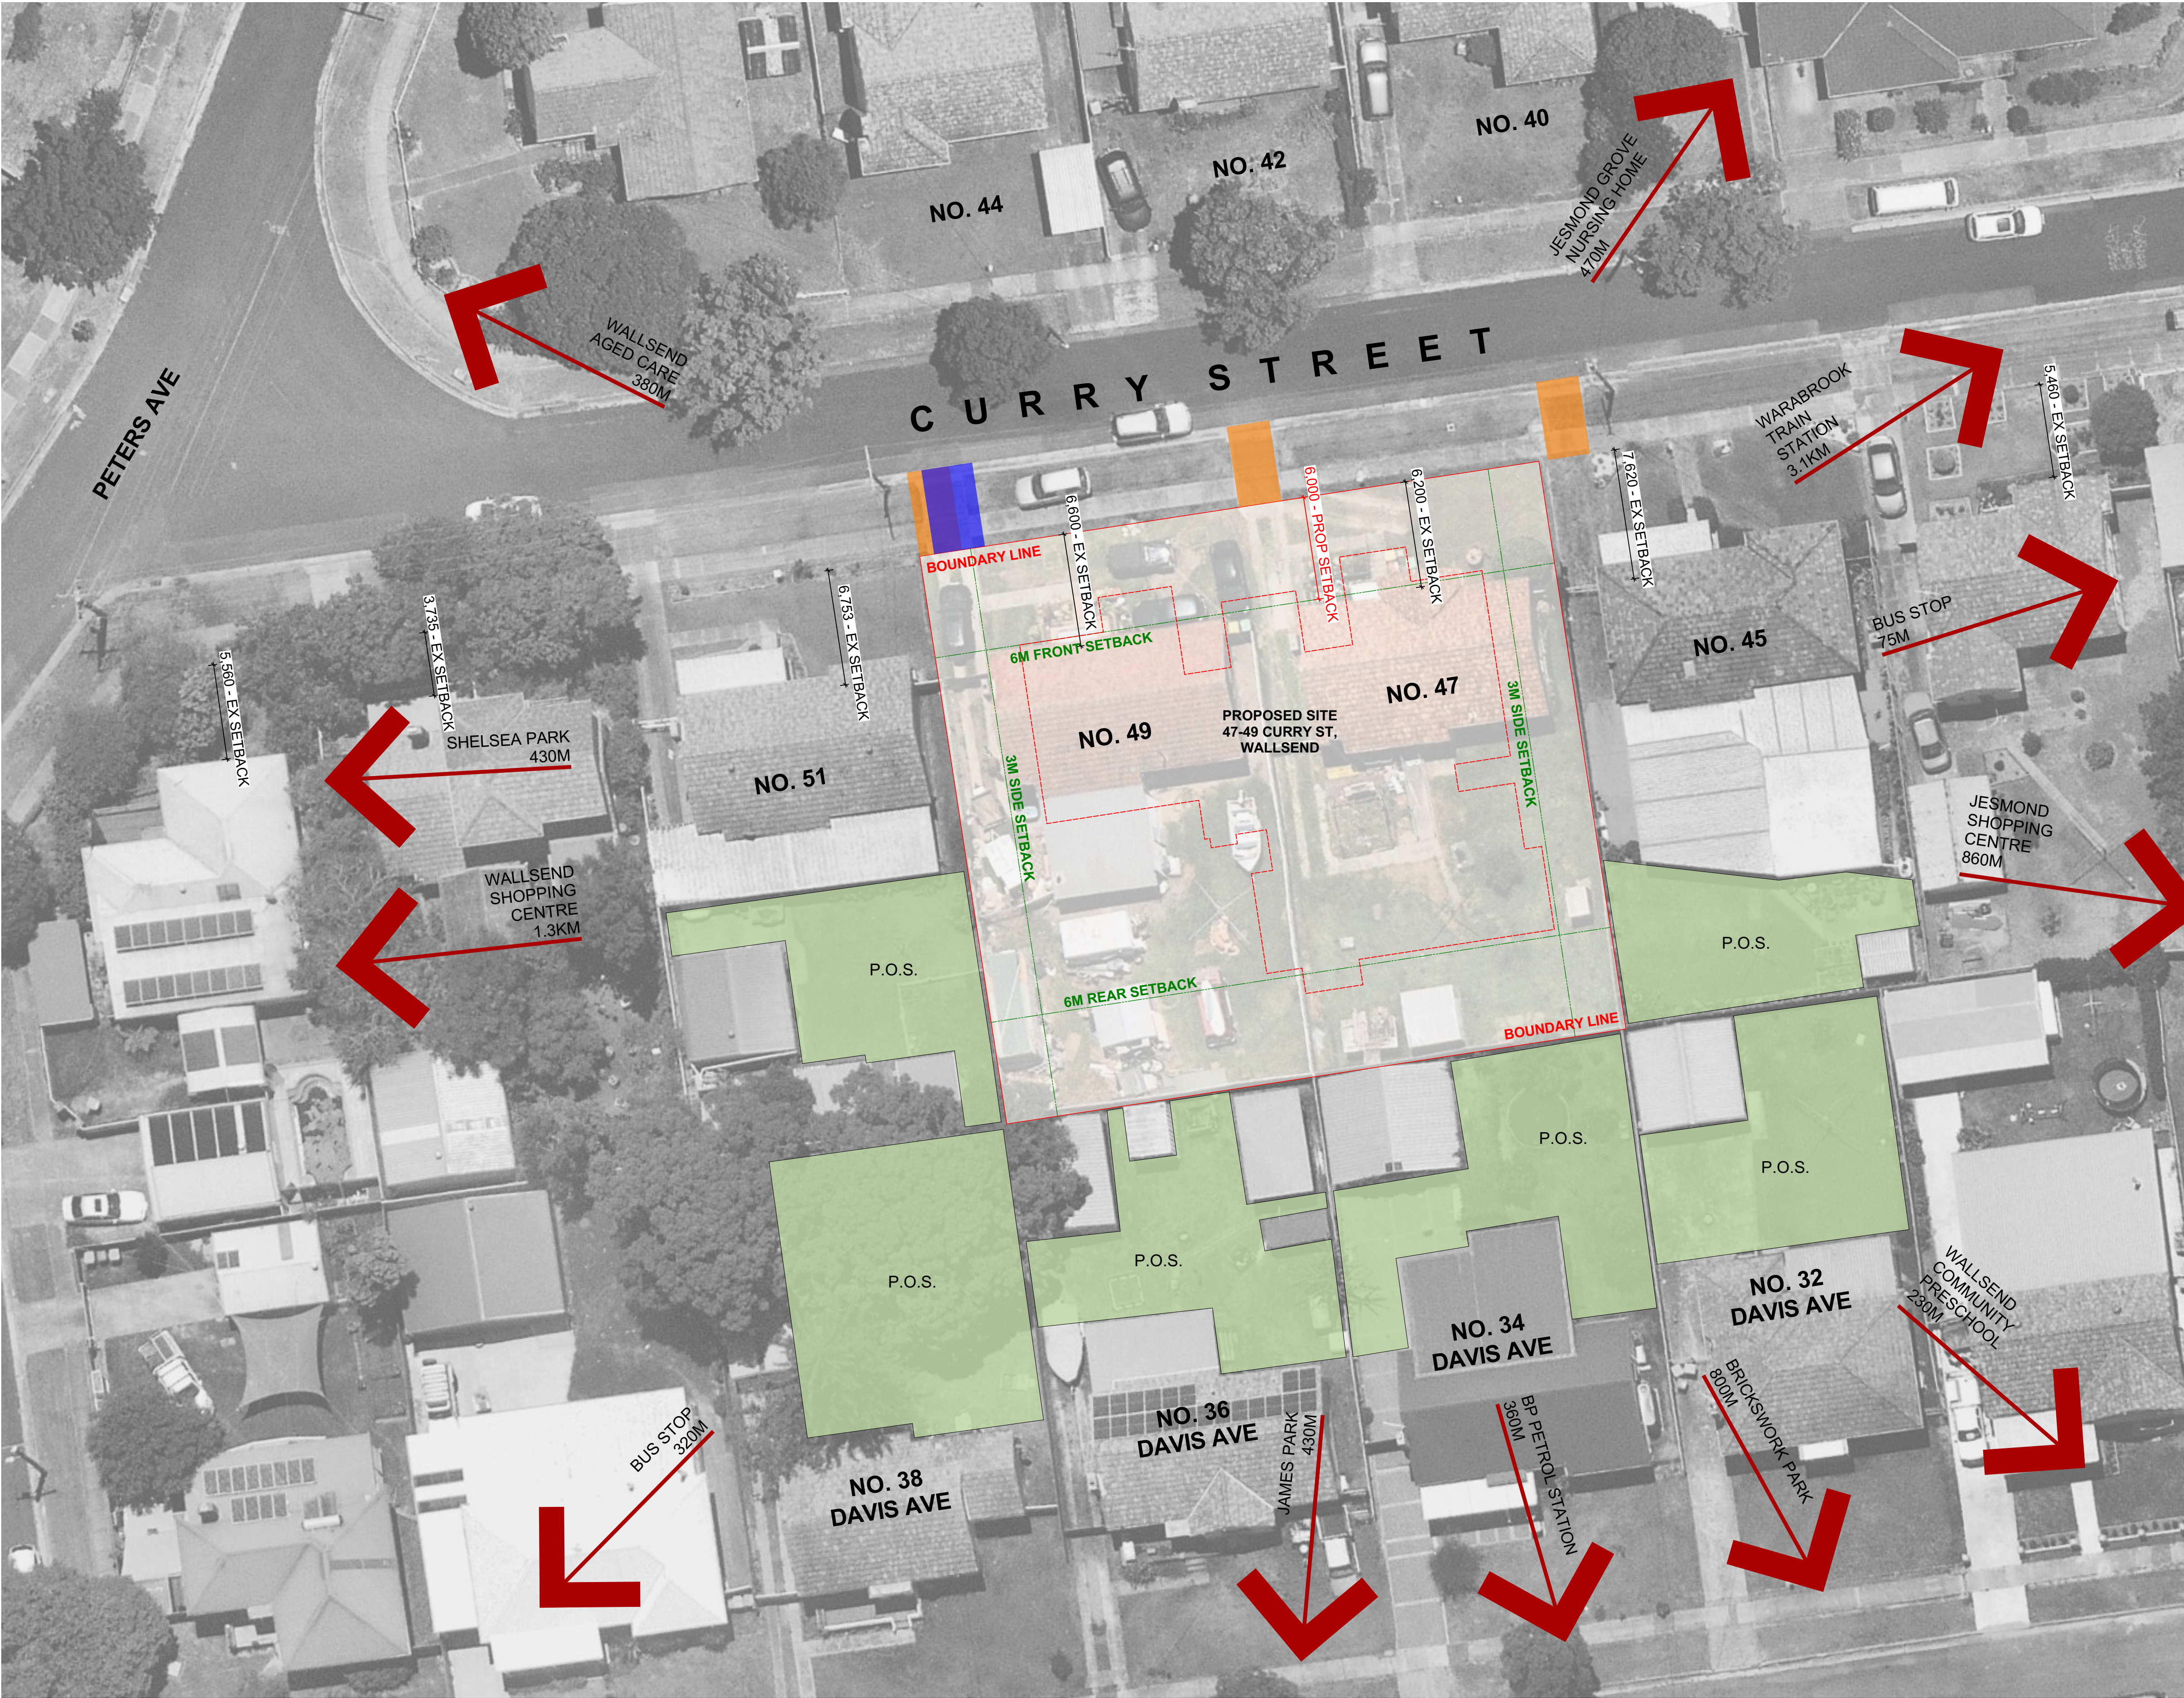


<b>1. BASIX Pathway</b>	
The following summary is the final review for the BASIX pathway based on the documents provided for architectural and building services design (AM2 Resubmission, dated 12/04/2022) on 25.05.2022.	
<b>1.1 Water Efficiency</b>	
Water score required: 40%	
Current score: 40%	
Common Facilities:	<ul style="list-style-type: none"><li>5000L RW Tank to collect rainwater from at least 360m2 of roof space to supply irrigation to at least 240m2 of common landscape and 135m2 of private landscape.</li></ul>
Dwellings:	<ul style="list-style-type: none"><li>Showerheads: 4-star WELS rated (&gt;4.5 but &lt;=6 L/min)</li><li>Kitchen Taps &amp; Bathroom Taps: 6-star WELS rated</li><li>Toilets: 4-star WELS rated</li><li>Clothes Washers: not specified</li><li>Dishwashers: not specified</li><li>No on-demand HW reticulation or diversion</li></ul>
<b>1.2 Energy Efficiency</b>	
Energy score required: 40%	
Current score: 40%	
Common Facilities:	<ul style="list-style-type: none"><li>Central Solar PV system: 2.0kW peak</li><li>No Central hot water systems</li><li>No Central heating / Cooling systems</li><li>No common area clothes dryers or drying lines.</li><li>No mechanical ventilation for common lobby for Ground and First Floor.</li><li>LED lights with manual switch on/off for Common Lobby for Ground and First Floor.</li></ul>
Dwellings:	<ul style="list-style-type: none"><li>Gas Instantaneous Hot Water System for individual dwellings</li><li>No Individual Heating systems</li><li>No Mechanical ventilation (i.e. natural ventilation) for bathroom for units 1,5,8,9.</li><li>Individual fan ducted to roof or facade exhausts for laundry, and kitchen for all units.</li><li>All Bathroom, Laundry, Kitchen exhausts are controlled by manual switch on/off.</li><li>Ceiling Fans provided for Living Room and Bedrooms for all units</li><li>No Individual Heating systems</li><li>Dedicated fluorescent or LED fittings for all internal rooms.</li><li>Electric cooktop and electric oven.</li><li>Dishwasher: not specified</li><li>Clothes Washer: not specified</li><li>Refrigerator and Clothes Dryer not specified.</li><li>Well Ventilated Fridge Space (as per plans).</li><li>Private Outdoor Clothing line for Units 1-5.</li><li>Indoor or sheltered clothes drying line (e.g. screened line on balcony or line over bath) for Units 6-9.</li></ul>
<b>1.3 Thermal Comfort</b>	
Score required: Pass	Current score: Pass
External Walls	Ground: Double Brick Cavity, R1.5 bulk insulation, plasterboard (as per elevations) Stud Wall with Fiber Cement Cladding, R1.5 bulk insulation, plasterboard First Floor: Brick Veneer, R1.5 bulk insulation, plasterboard (as per elevations) Stud Wall with Fiber Cement Cladding, R1.5 bulk insulation, plasterboard
External Wall Solar absorbance	0.5 (grey)
Internal Partitions	Lightweight Construction – Plasterboard Stud Cavity Wall, No Insulation
Party Walls – walls to risers, shafts, neighbours	Lightweight Construction – Plasterboard Stud Cavity Wall, No Insulation
Walls to naturally ventilated corridors	Single Brick – Plasterboard, No insulation
Ceiling to Roof (ceiling to balcony)	Plasterboard, R3.5 bulk insulation
Roof construction	Corrugated Iron, No Insulation, Skillion roof
Roof Solar absorbance	Solar Absorbance – 0.5 (grey)
Floor construction	Concrete Slab
Suspended Floor constructions	Concrete Slab, Bulk Insulation in Contact with Floor R2.0
Floor coverings	Tiles in Dining, study, and living, bedrooms Tiles in wet areas (kitchen, laundry, toilet)
Window system performance	Awnings, Casement - U-Value of 4.5 and SHGC of 0.50 Sliding, Fixed, - U-Value of 4.3 and SHGC of 0.53
Window operability	Window operability according to the plans. Single Pane Awning windows on the ground floor have been modeled to 90% openness. The combination of casement and fixed windows on the ground floor are modeled to 45% openness. Operable windows above 2m off the ground and not next to balconies or winter garden have been modeled to have a 10% openness in the models.
Ceiling Penetrations	Surface mounted LED lights. Weather seals for all exhausts and vents have been assumed in all models.



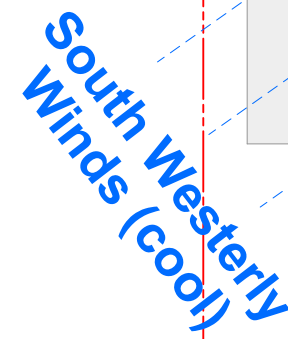

*John*

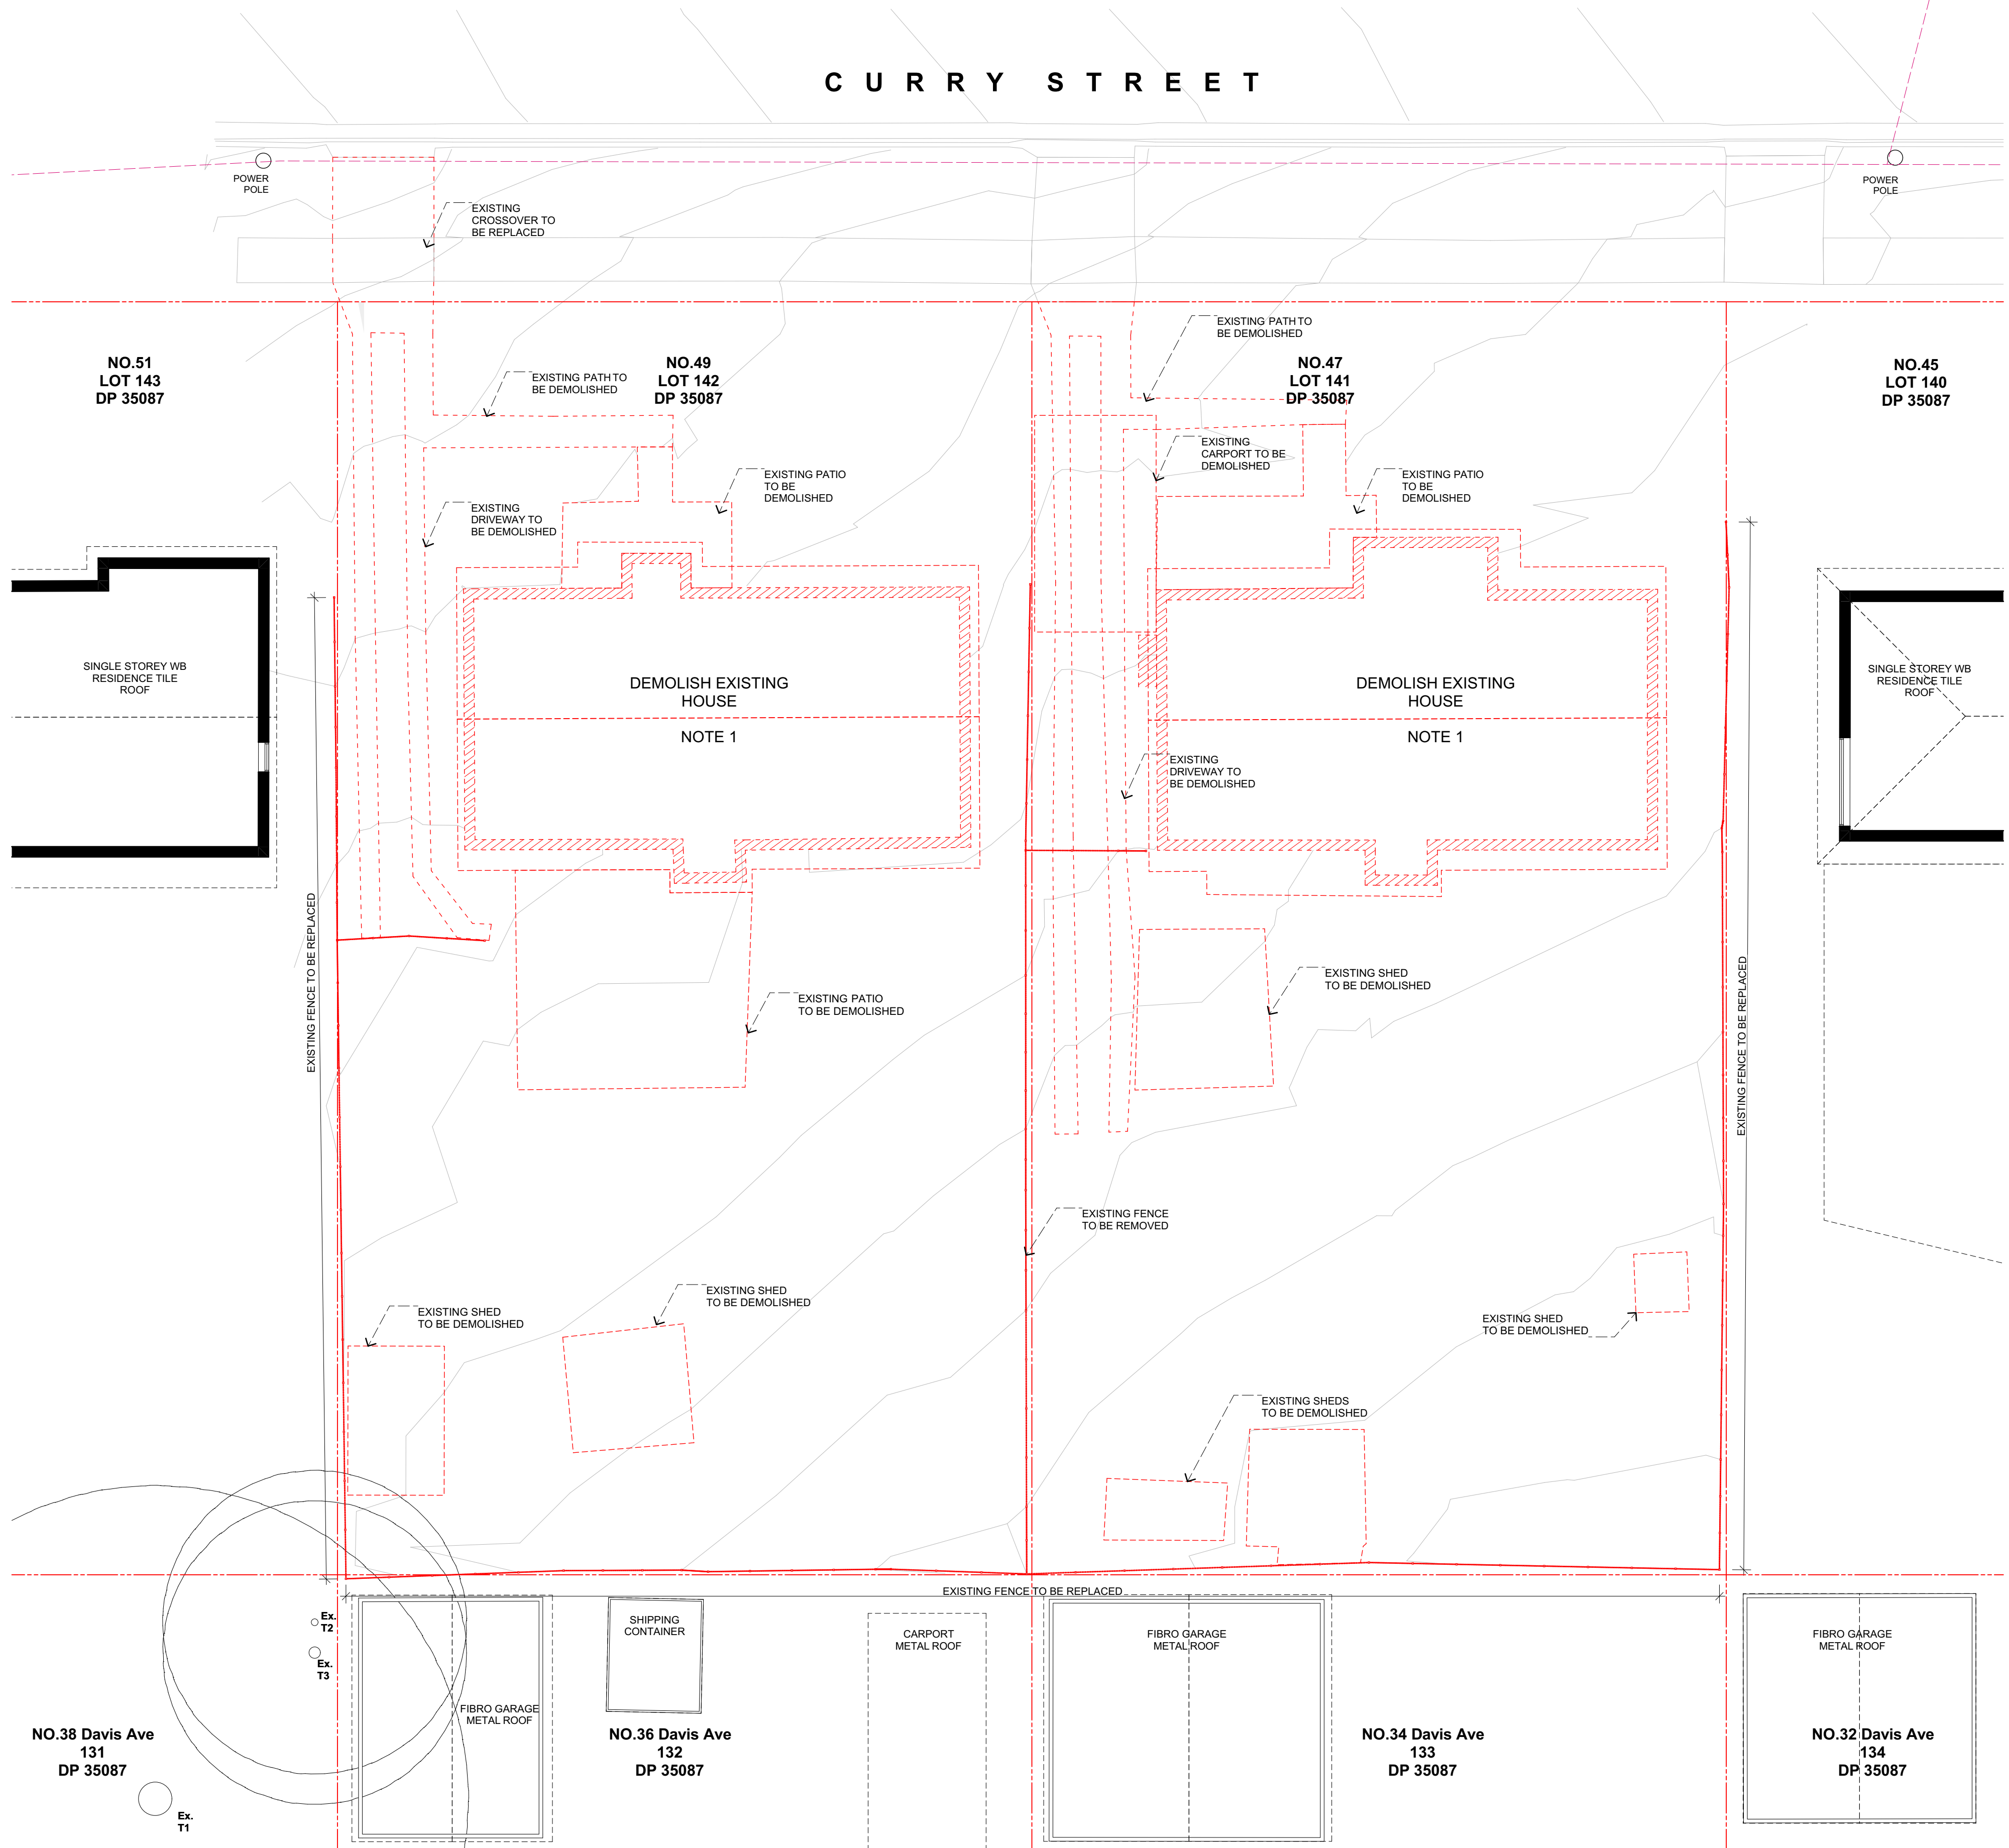

**NOTES**





NOTE 1:  
DEMOLISH SINGLE STOREY FIBRO  
RESIDENCE WITH TILED ROOF INCLUDING  
SLABS AND FOOTINGS.

NOTE 2:  
DEMOLISH EXISTING EXTERNAL CONCRETE  
AREAS





Locality/Suburb		WALLSEND					
Street Address		47 & 49 Curry Street					
Lot Number(s) & Deposited Plan		Lot 141 & 142 DP 35087					
SITE AREA (m²)		Lot 141 - 613.16 Lot 142 - 613.16 Total - 1226.32 m²					
NUMBER OF EXISTING LOTS		2					
PROPOSED GFA (m²)		652					
NUMBER OF DWELLINGS		4 x 1 Bed 5 x 2 Bed = 9 Dwellings					
DWELLINGS	Number	Type	No. of Bedrooms	GFA Ground (m²)	GFA First (m²)	POS	
	1	Ground	2	70		92	
	2	Ground	1	52		44	
	3	Ground (Adaptable)	2	78		43	
	4	Ground	1	51		70	
	5	Ground	1	51		37	
	6	First	2		70	10	
	7	First	1		52	8	
	8	First	2		78	11	
	9	First	2		73	11	
LOBBY		Ground	43				
		First		34			
TOTAL			14	652	326		
		CONTROL		REQUIREMENT		PROPOSED	
HEIGHT		Housing SEPP		9m		Maximum 8.08m - Complies	
		Newcastle LEP		8.5 m			
FSR		Newcastle LEP		0.6 : 1 (Max. 736 m²)		0.53 to 1 - Complies	
SETBACK		Newcastle DCP	Front Street Setback	Avg. neighbouring - 6m		GF minimum - 6m 1F minimum - 3.9m - Encroachment for 1F Balconies	
			Side Setback	0.9m up to 4.5m - above 4.5m at an angle of 4:1 to max permitted height		GF minimum - 3.25m 1F minimum - 4.25m - Complies	
			Secondary Setback	2m		N/A	
			Rear Setback	3m up to 4.5m 6m setback for greater than 4.5m		GF and 1F - 6.75m - Complies	
PARKING		Housing SEPP (Division 6)		0.4 x 4 (1 Bed) = 1.6 0.5 x 5 (2 Bed) = 2.5 (total 5 spaces, incl. 1 accessible space)		Total provided 5 - Complies	
LANDSCAPE		Newcastle DCP	General	Min 30% of site area = 368 m²		Proposed 388 m² - Complies	
DEEP SOIL		Newcastle DCP	General	15% of site area = 184 m²		Total provided 235 m² - Complies	
SOLAR ACCESS		SLUDG	General	70% of dwellings receive min 3 hrs sunlight to Living & POS in Mid-Winter		7 / 9 Living Rooms	7 / 9 POS
DWELLING SIZE		LAHC Dwelling Requirements	General	1 Bedroom dwelling: Min 50m² 2 Bedroom dwelling: Min 70m²		Complies	
PRIVATE OPEN SPACE		LAHC Dwelling Requirements	General	GF: Not less than 15 m² per unit Min dimension 3m  FF: 10 m² per 2 bed unit Min dimension 2m & 8 m² per 1 bed unit Min dimension 2m		Complies	

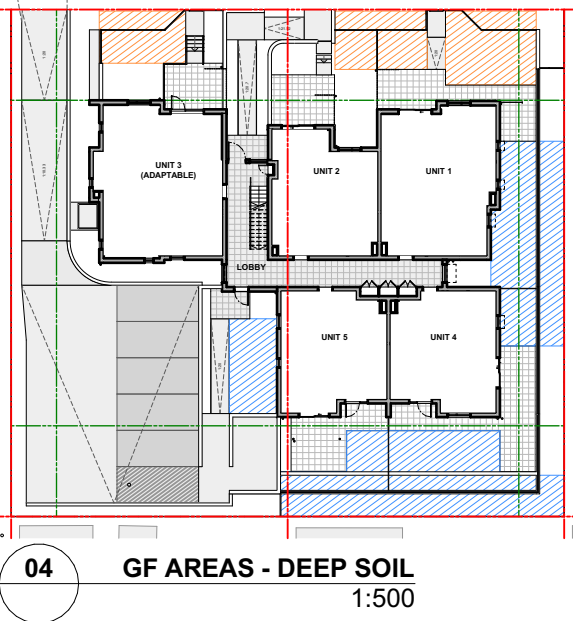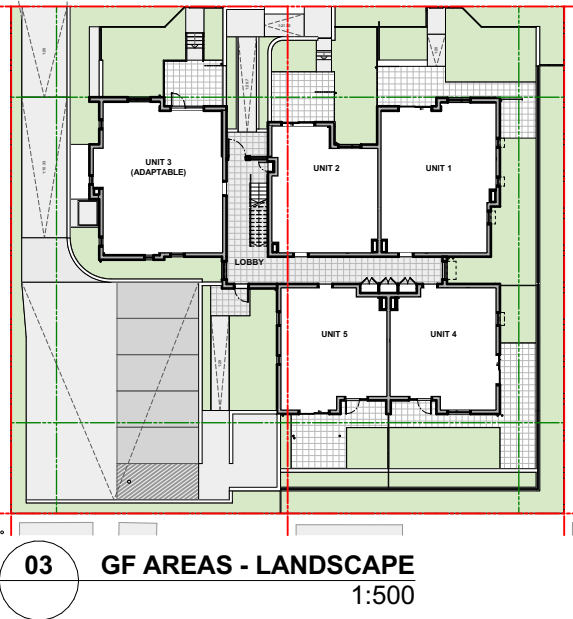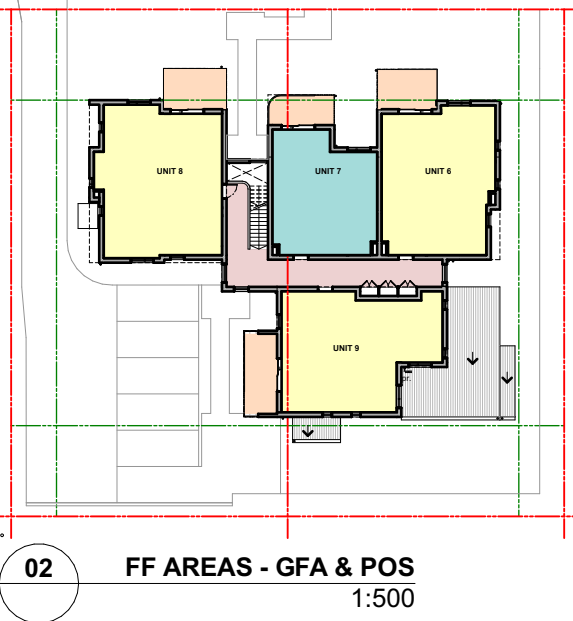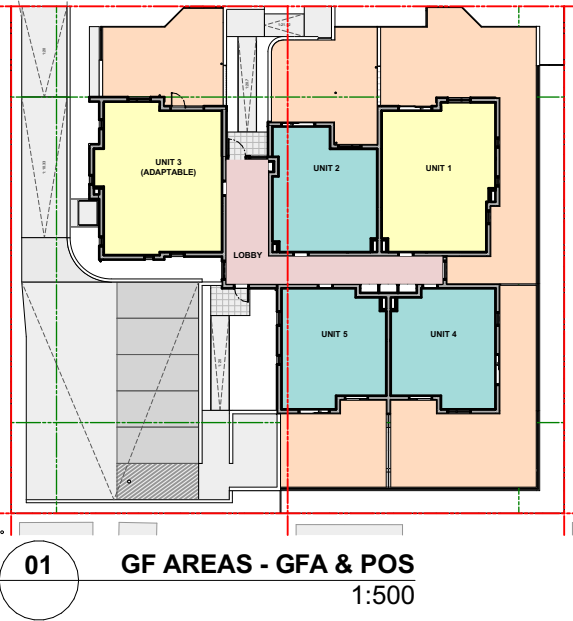


LEGEND

- GFA - 1 BED UNITS
- GFA - 2 BED UNITS
- GFA - PRIVATE OPEN SPACE
- GFA - COMMON AREA
- LANDSCAPE AREA
- DEEP SOIL FRONT OF SETBACK
- DEEP SOIL REAR OF SETBACK






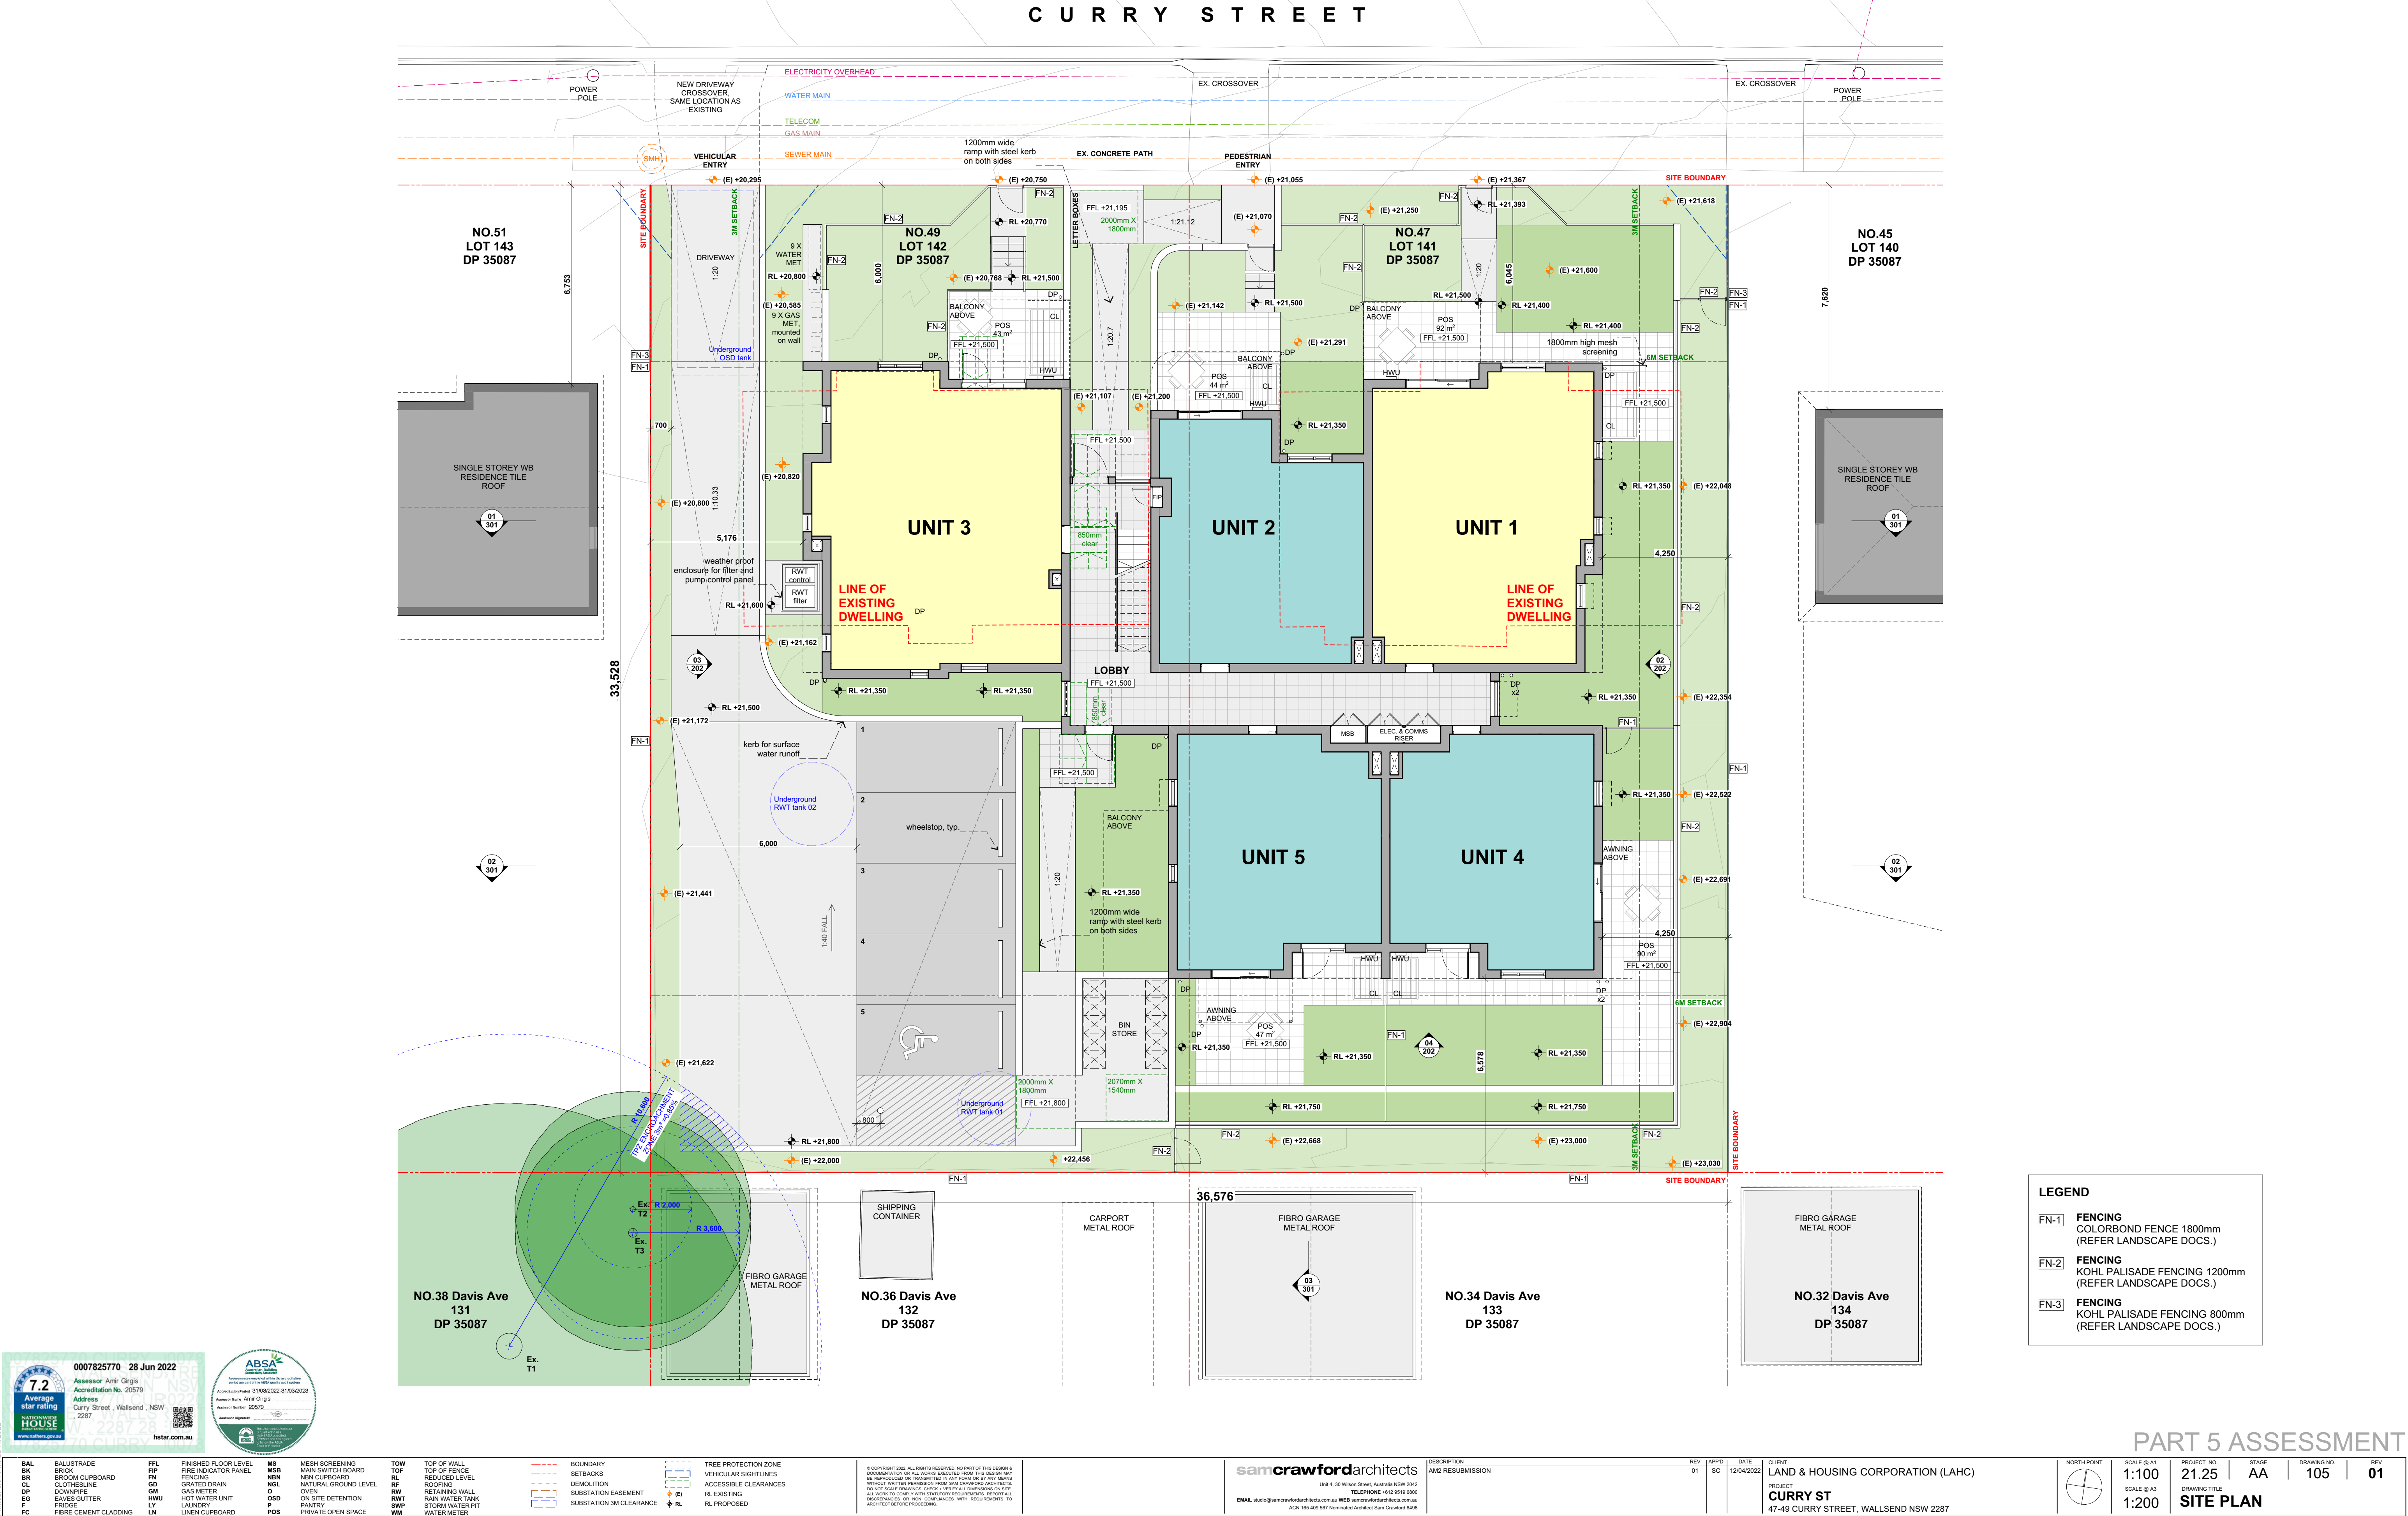

LEGEND	
FN-1	FENCING COLORBOND FENCE 1800mm (REFER LANDSCAPE DOCS.)
FN-2	FENCING KOHL PALISADE FENCING 1200mm (REFER LANDSCAPE DOCS.)
FN-3	FENCING KOHL PALISADE FENCING 800mm (REFER LANDSCAPE DOCS.)




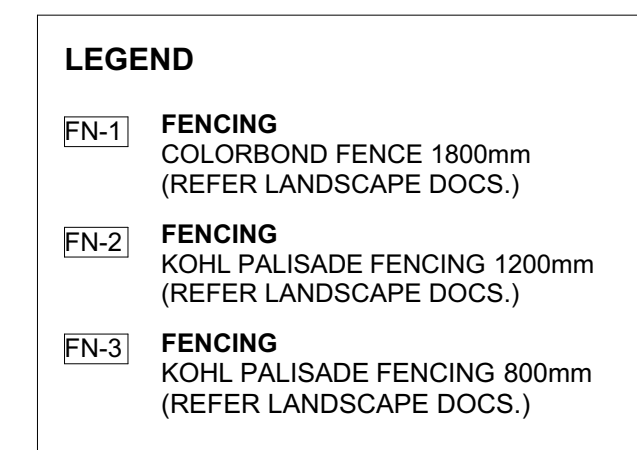





*Eden*

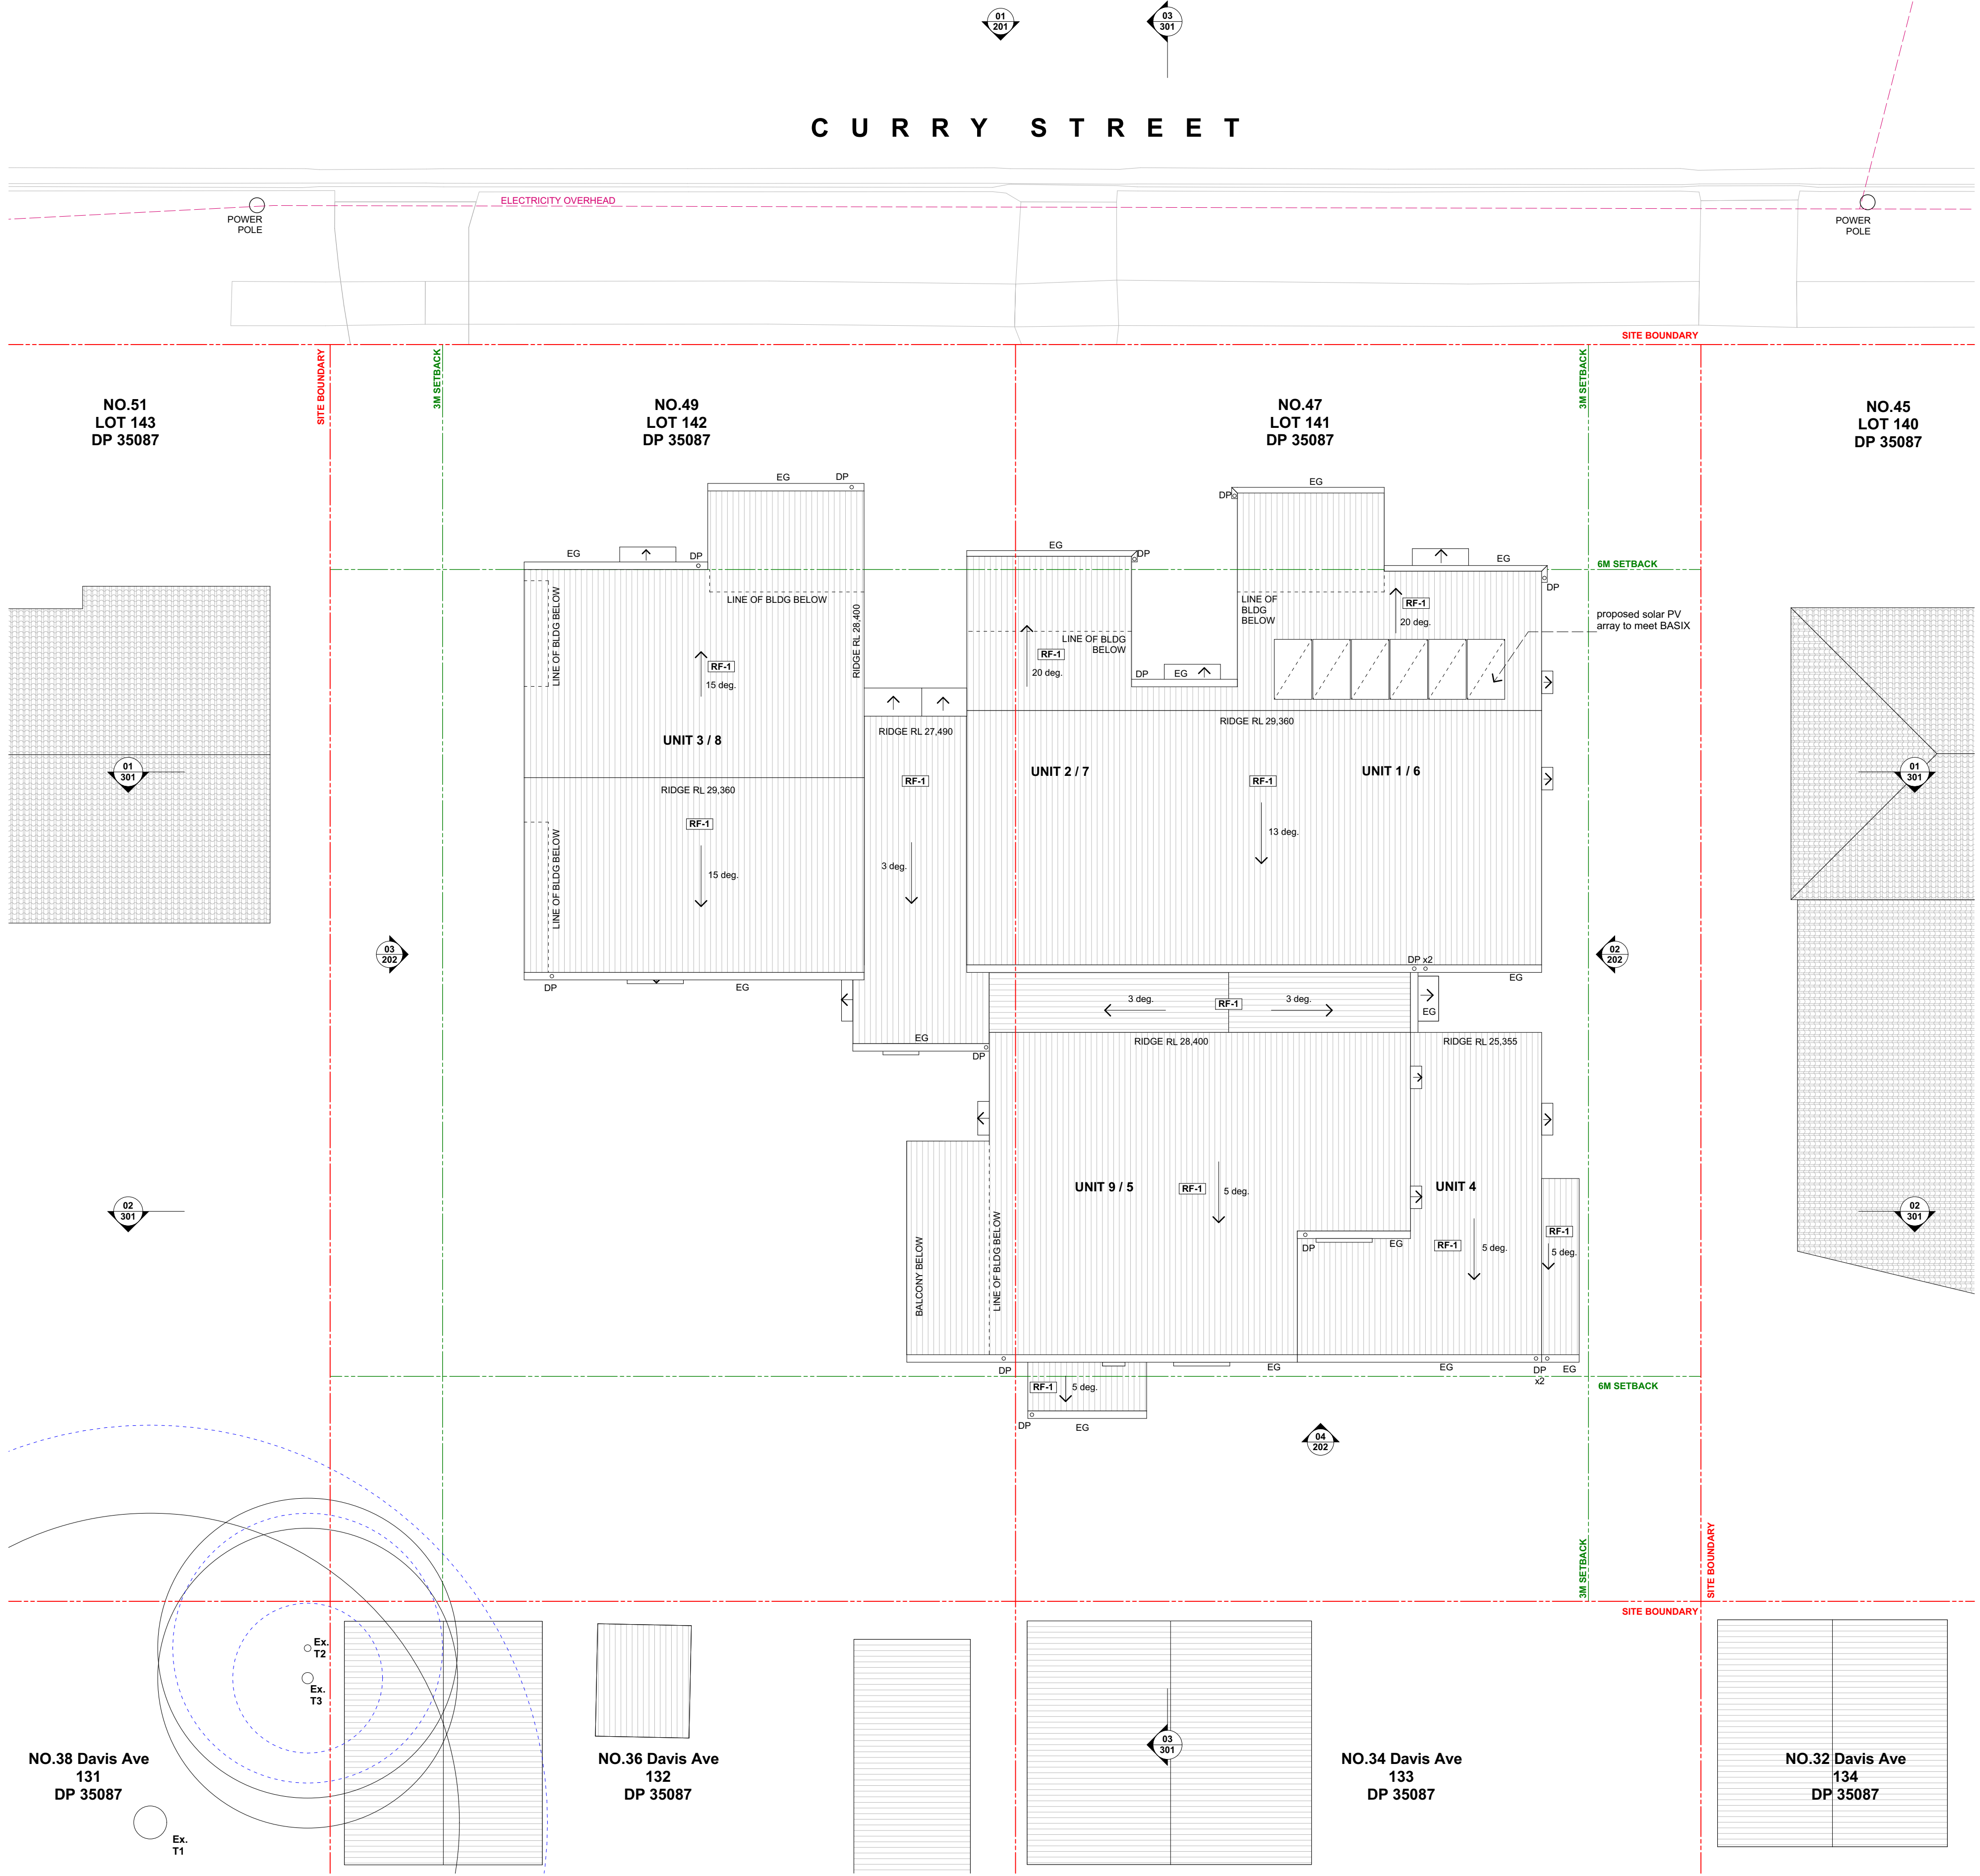





**LEGEND**

- SILVER LEVEL COMPLIANCE
- GOLD LEVEL COMPLIANCE

0007825770 28 Jun 2022  
Assessor Amir Giris  
Accreditation No. 20579  
Address  
Curry Street, WallSEND NSW  
2287  
hstar.com.au

ABSA  
Accreditation No. 3163022-3163023  
Assessor Amir Giris  
Assessment Number 20579  
Assessor's Signature

BAL	BALUSTRADE	FFL	FINISHED FLOOR LEVEL	MS	MESH SCREENING	TOW	TOP OF WALL
BK	BRICK	FI	FIRE INDICATOR PANEL	MSB	MAIN SWITCH BOARD	TOF	TOP OF FENCE
BR	BROOM CUPBOARD	FN	FENCING	NBN	NBN CUPBOARD	RL	REDUCED LEVEL
CL	CLOTHESLINE	GD	GRATED DRAIN	NGL	NATURAL GROUND LEVEL	RF	ROOFING
DP	DOWNPIPE	GM	GAS METER	O	OVEN	RW	RETAINING WALL
EG	EAVES OUTTER	HWU	HOT WATER UNIT	OSD	ON SITE DETENTION	RWT	RAIN WATER TANK
F	FROST	LY	LAUNDRY	P	PANTRY	SWP	STORM WATER PIT
FC	FIBRE CEMENT CLADDING	LN	LINEN CUPBOARD	POS	PRIVATE OPEN SPACE	WM	WATER METER

BOUNDARY	SETBACKS	DEMOLITION	SUBSTATION EASEMENT	SUBSTATION 3M CLEARANCE
VEHICULAR SIGHTLINES	ACCESSIBLE CLEARANCES	EXISTING	PROPOSED	


TREE PROTECTION ZONE	VEHICULAR SIGHTLINES	ACCESSIBLE CLEARANCES	EXISTING	PROPOSED
RL				

samcrawfordarchitects  
Unit 4, 30 Wilson Street, Australia NSW 2042  
TELEPHONE +61 2 919 9800  
EMAIL studio@samcrawfordarchitects.com.au WEB samcrawfordarchitects.com.au  
ACN 165 405 987 Nominated Architect Sam Crawford 6498

DESCRIPTION	70% DA FOR LAHC REVIEW
AND SUBMISSION	AND RESUBMISSION

REV	APPRO	DATE	CLIENT
P1	SC	4/02/2022	LAND & HOUSING CORPORATION (LAHC)
P2	SC	8/03/2022	
P3	SC	12/04/2022	

PROJECT	LAND & HOUSING CORPORATION (LAHC)
DRAWING TITLE	CURRY ST
	47-49 CURRY STREET, WALLSEND NSW 2287


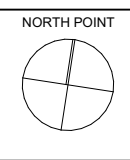


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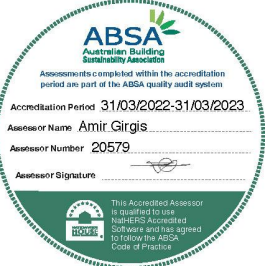
PART 5 ASSESSMENT



*John*

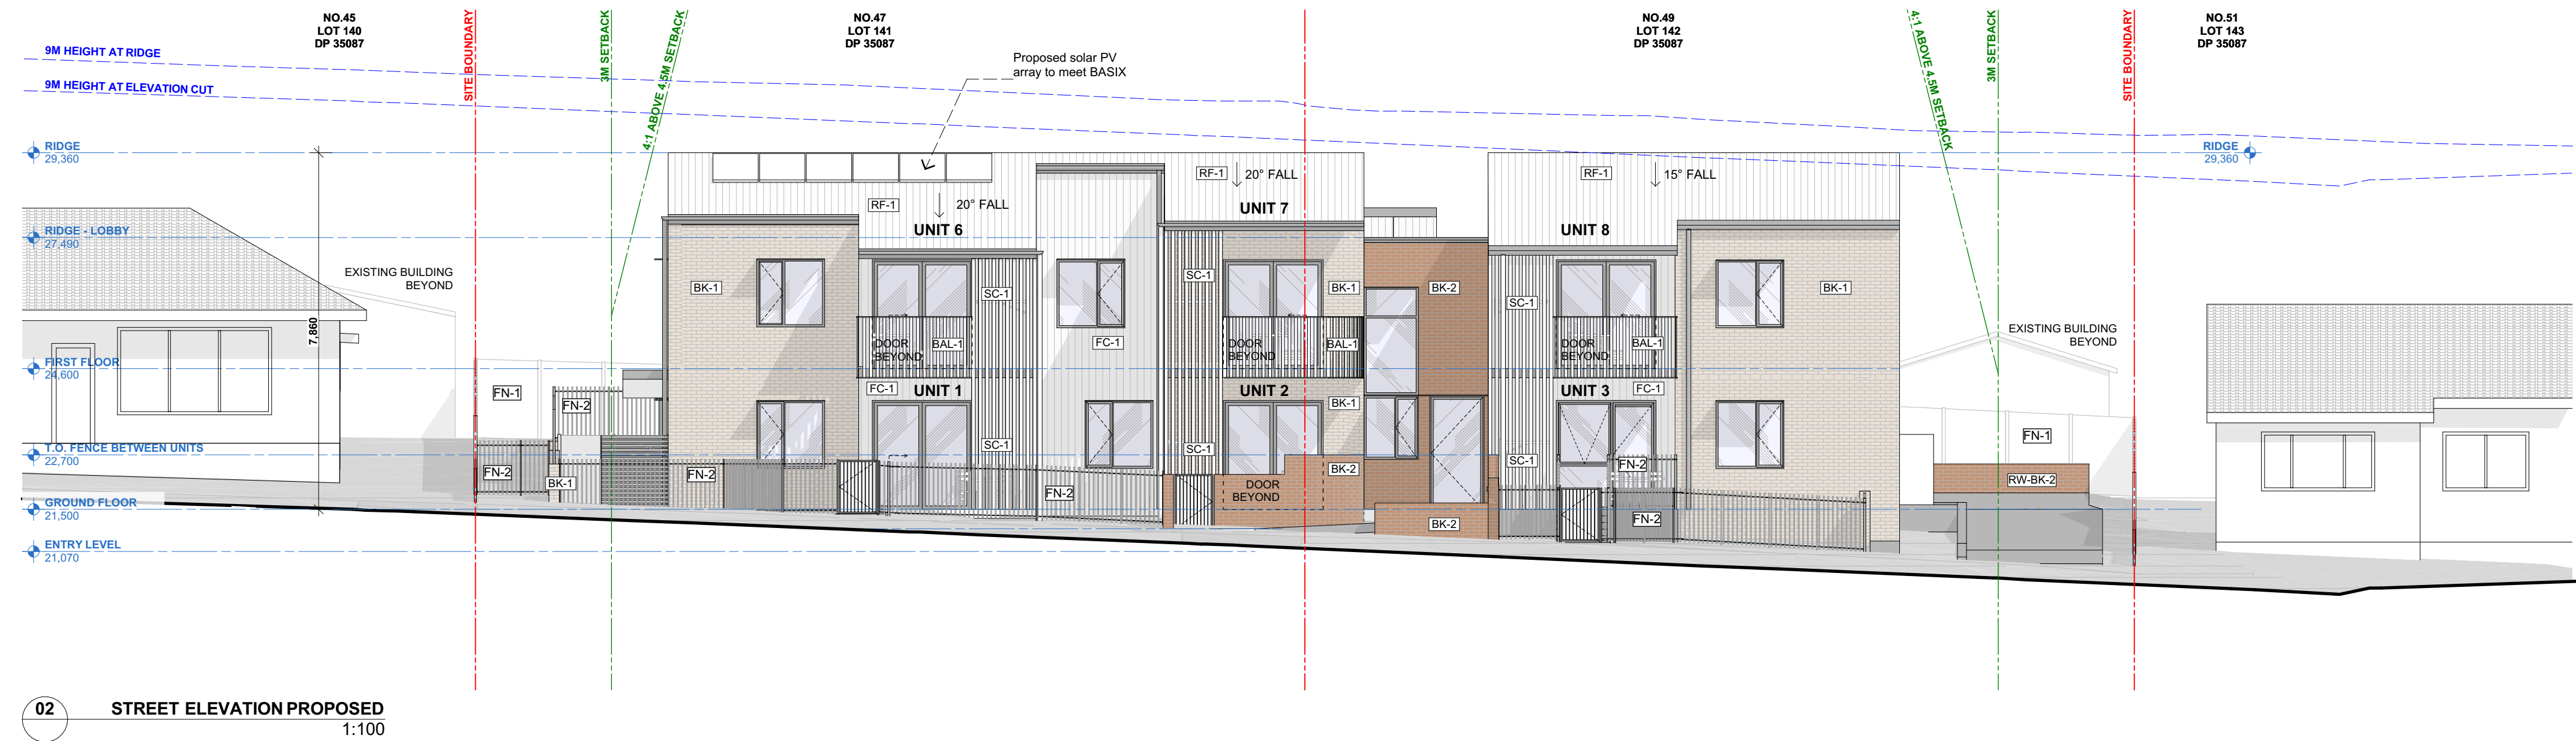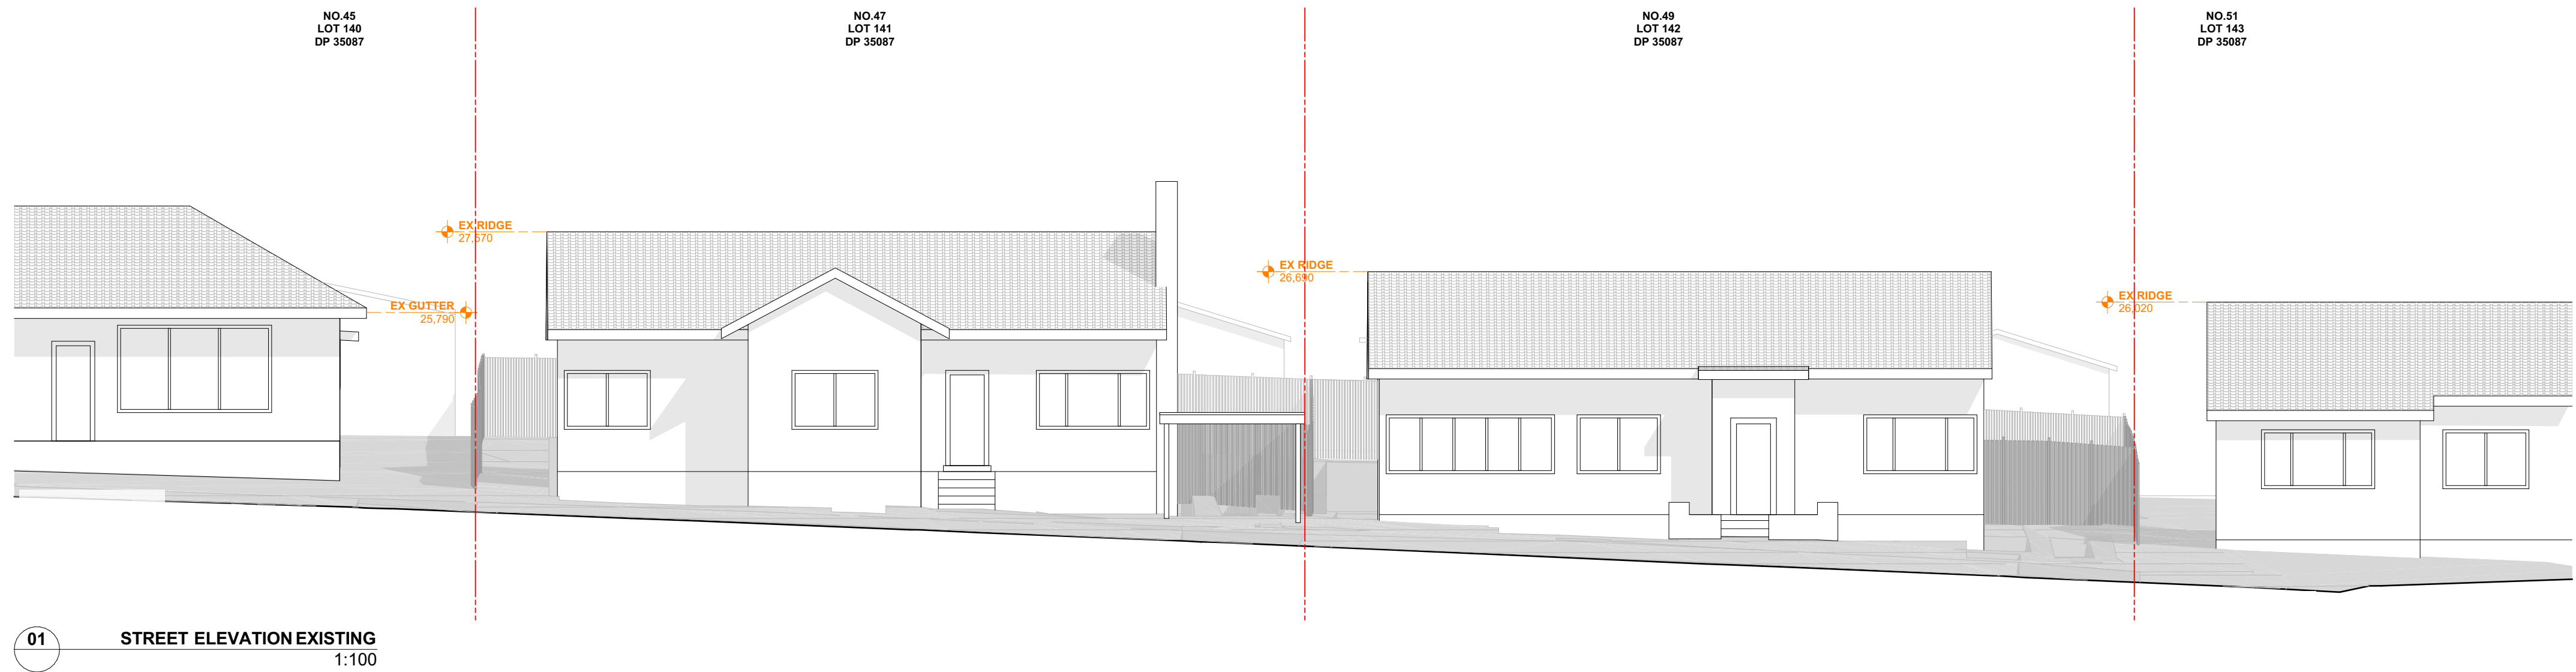

- EXTERNAL FINISHES**
- BAL-1 **BALUSTRADE**  
METAL BALUSTRADE IN LEXICON QUARTER
  - BK-1 **WALLS**  
BRICK - PGH COASTAL HAMPTONS - GULL GREY
  - BK-2 **WALLS**  
BRICK - PGH TOWNHOUSE - KENT
  - FC-1 **WALLS**  
FIBRE CEMENT CLADDING - JAMES HARDIE AXON CLADDING SMOOTH 133
  - RW-BK **RETAINING WALL**  
CONCRETE BLOCKWORK - WITH FACE BRICK BK-1 OR BK-2 (REFER ELEVATIONS)
  - FN-1 **FENCING**  
COLORBOND FENCE 1800mm (REFER LANDSCAPE DOCS.)
  - FN-2 **FENCING**  
KOHL PALISADE FENCING 1200mm (REFER LANDSCAPE DOCS.)
  - FN-3 **FENCING**  
KOHL PALISADE FENCING 800mm (REFER LANDSCAPE DOCS.)
  - SC-1 **SCREENS**  
ALUMINIUM VERTICAL BATTENS
  - RF-1 **ROOF**  
CORRUGATED METAL ROOF - LYSAGHT CUSTOM ORB SHALE GREY
  - MC-1 **METAL CLADDING**  
FINISH TO BE IN SHALE GREY
  - WINDOWS AND DOORS**  
ALUMINIUM FRAME



BAL	BALUSTRADE
BK	BRICK
BR	BROOM CUPBOARD
CL	CLOTHESLINE
DP	DOWNPIPE
EG	EAVES GUTTER
F	FIBRE CEMENT CLADDING
FC	FIBRE CEMENT CLADDING

FFL	FINISHED FLOOR LEVEL
FI	FIRE INDICATOR PANEL
FN	FENCING
GD	GRATED DRAIN
GM	GAS METER
HWU	HOT WATER UNIT
LY	LAUNDRY
LN	LINEN CUPBOARD

MS	MESH SCREENING
MSB	MAIN SWITCH BOARD
NBN	NBN CUPBOARD
NGL	NATURAL GROUND LEVEL
O	OVER
OSD	ON SITE DETENTION
P	PANTRY
POS	PRIVATE OPEN SPACE

TOW	TOP OF WALL
TOF	TOP OF FENCE
RL	REDUCED LEVEL
RF	ROOFING
RW	RETAINING WALL
RWT	RAIN WATER TANK
SNP	STORM WATER PIT
WM	WATER METER

BOUNDARY	BOUNDARY
SETBACKS	SETBACKS
DEMOLITION	DEMOLITION
SUBSTANTION EASEMENT	SUBSTANTION EASEMENT
SUBSTANTION 3M CLEARANCE	SUBSTANTION 3M CLEARANCE

TREE PROTECTION ZONE	TREE PROTECTION ZONE
VEHICULAR SIGHTLINES	VEHICULAR SIGHTLINES
ACCESSIBLE CLEARANCES	ACCESSIBLE CLEARANCES
RL EXISTING	RL EXISTING
RL PROPOSED	RL PROPOSED

70% DA FOR LAHC REVIEW	70% DA FOR LAHC REVIEW
AND SUBMISSION	AND SUBMISSION
AND RESUBMISSION	AND RESUBMISSION

DESCRIPTION	DESCRIPTION
70% DA FOR LAHC REVIEW	70% DA FOR LAHC REVIEW
AND SUBMISSION	AND SUBMISSION
AND RESUBMISSION	AND RESUBMISSION

REV	APPRO	DATE	CLIENT
P1	SC	4/02/2022	LAND & HOUSING CORPORATION (LAHC)
P2	SC	8/03/2022	PROJECT
P3	SC	12/04/2022	CURRY ST

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SCALE @ A1	PROJECT NO.	STAGE	DRAWING NO.	REV
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SCALE @ A3				
1:200				

SCALE @ A1	PROJECT NO.	STAGE	DRAWING NO.	REV
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SCALE @ A3				
1:200				

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SCALE @ A3				
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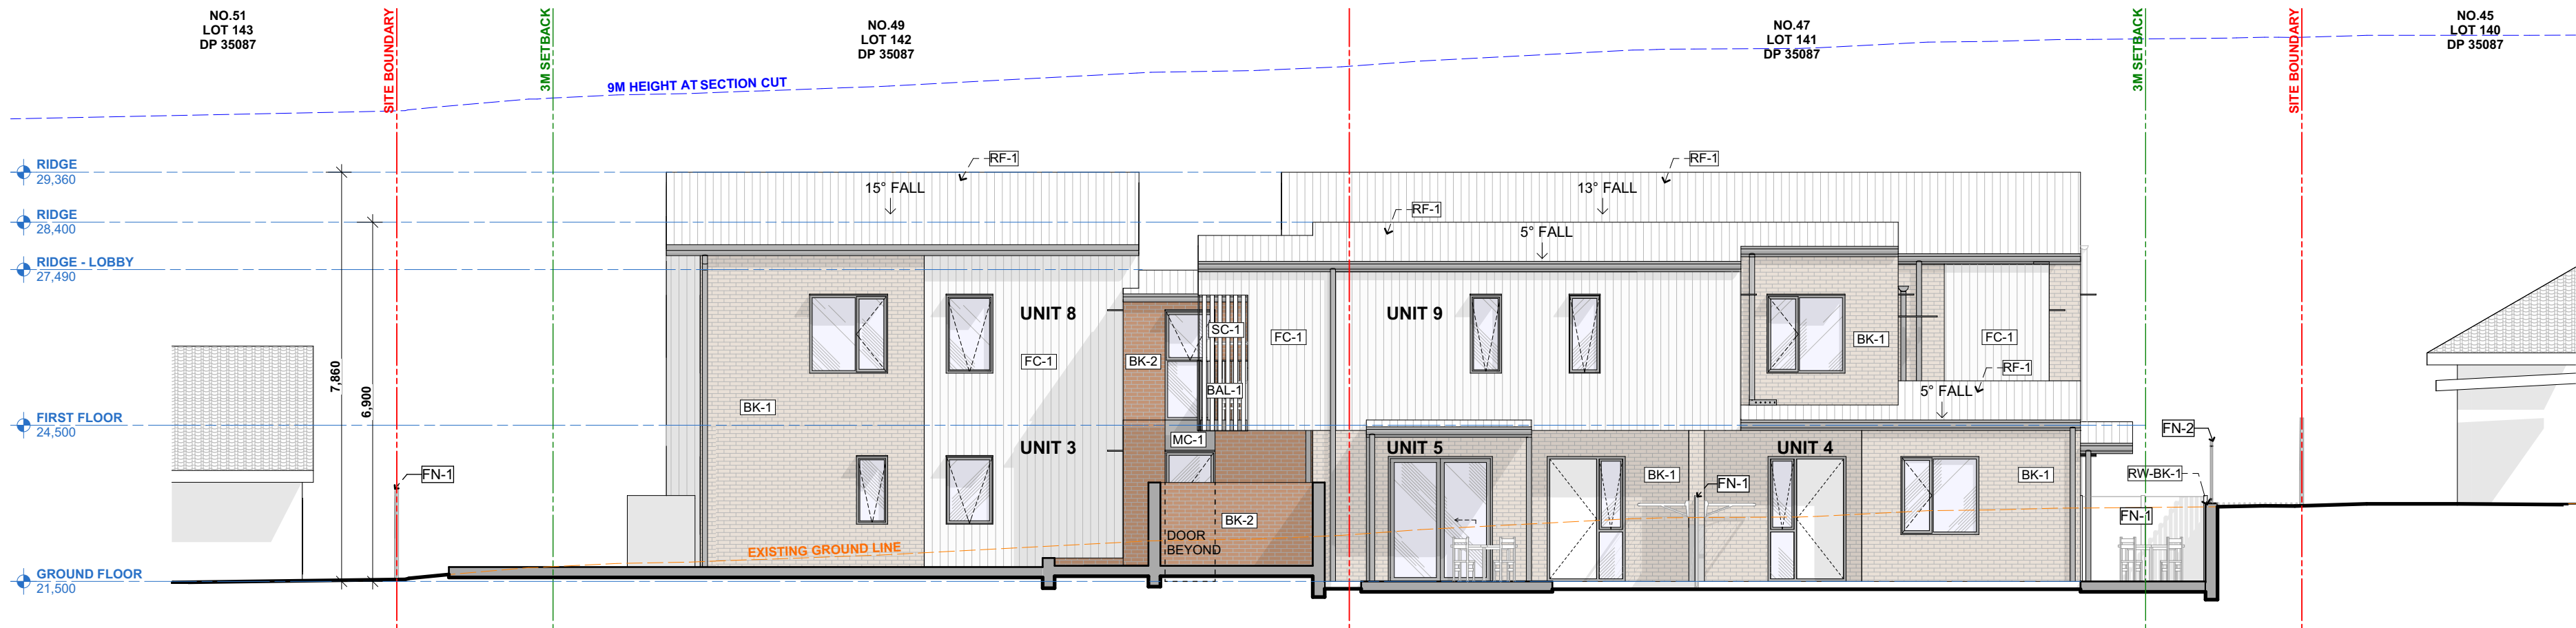
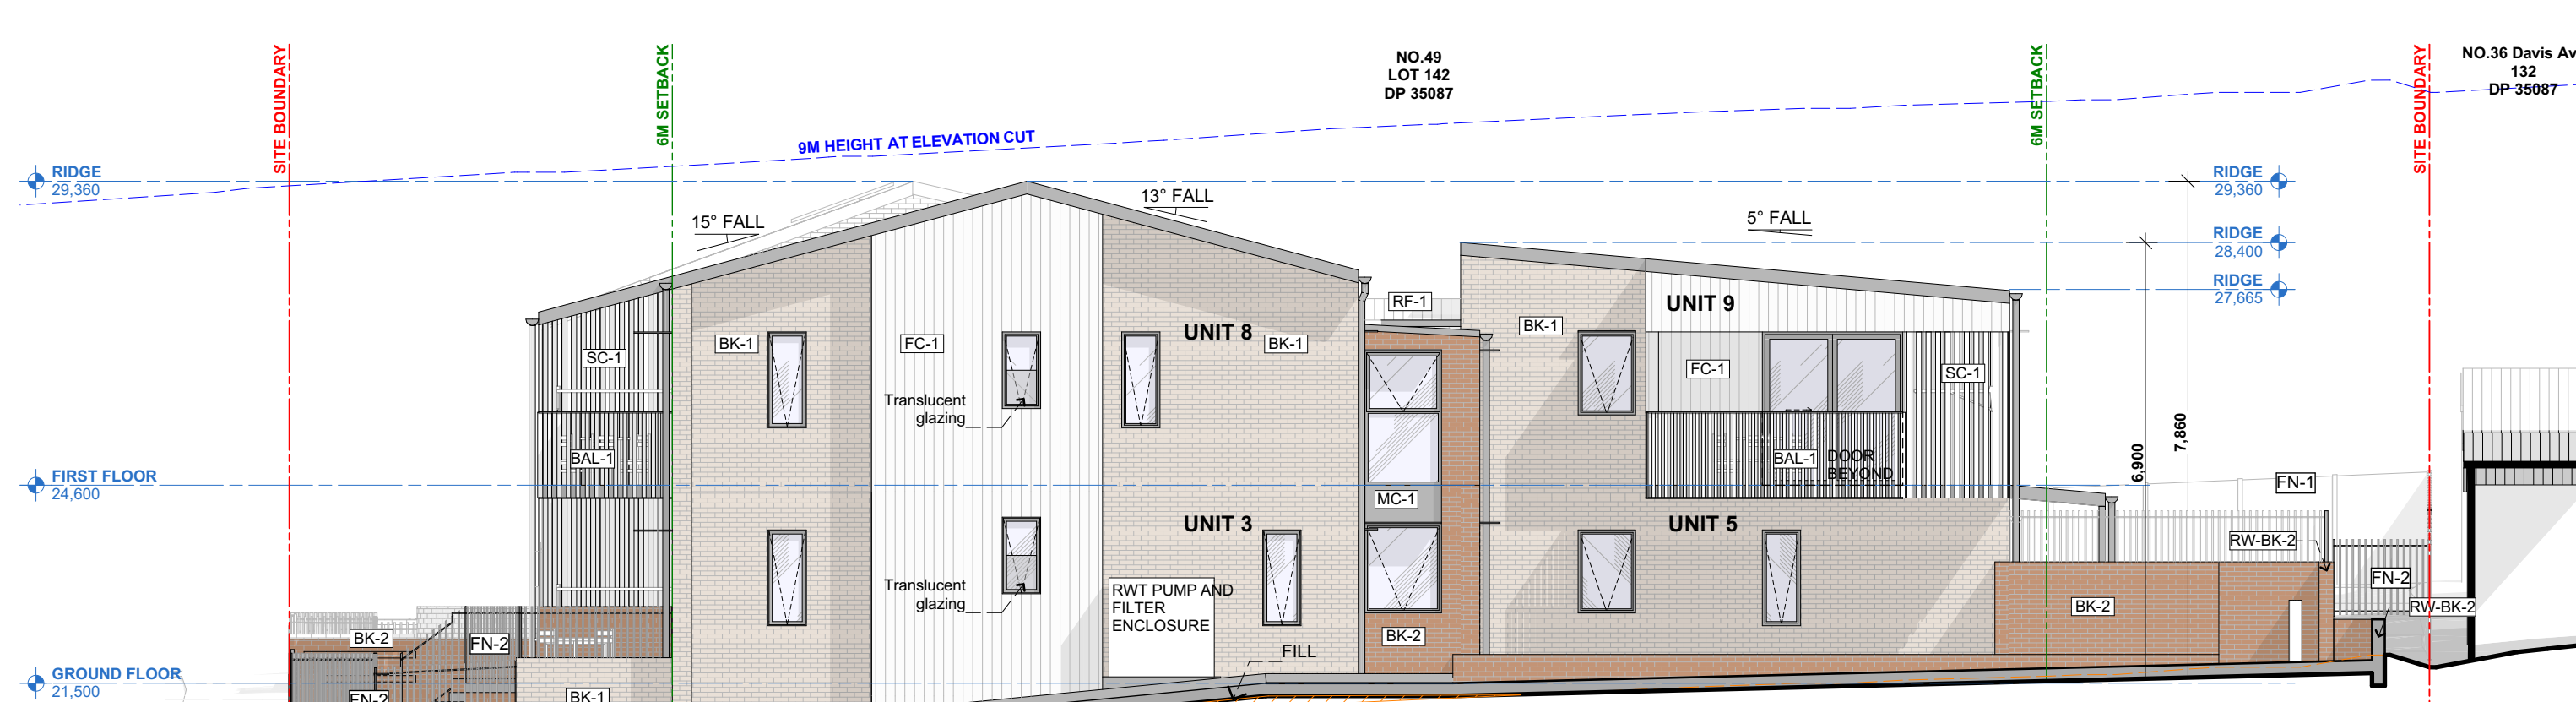
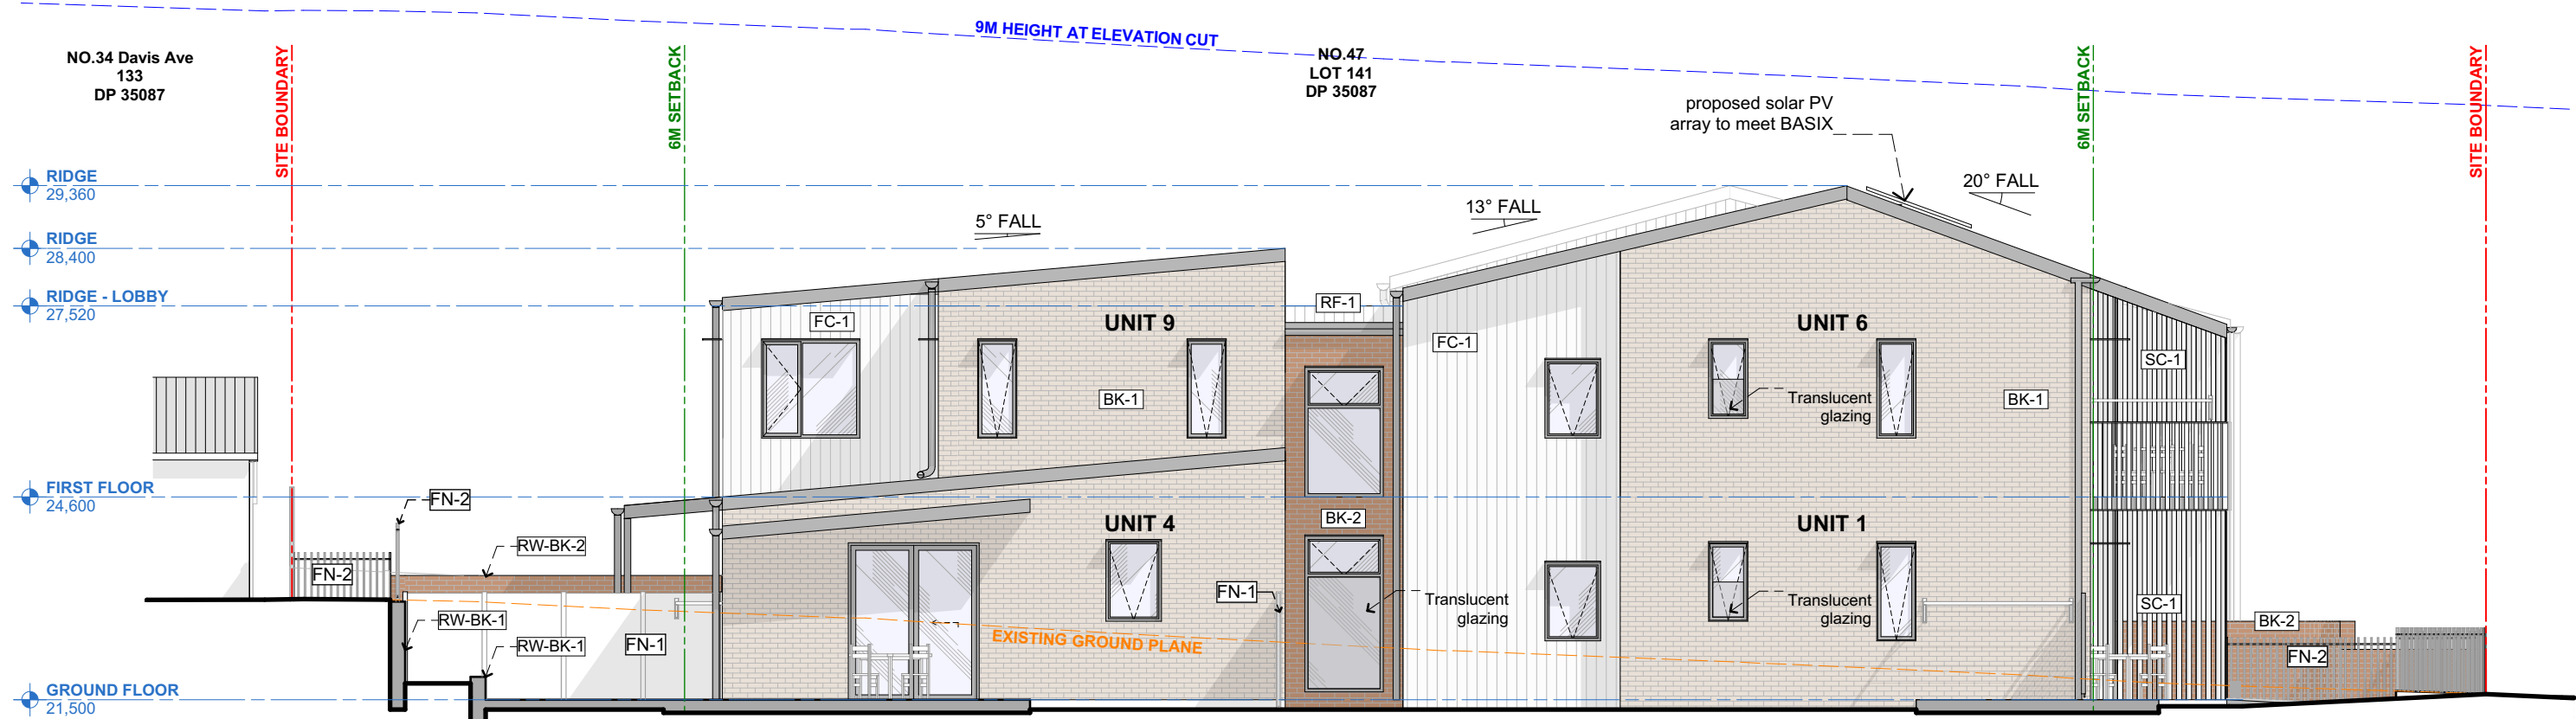
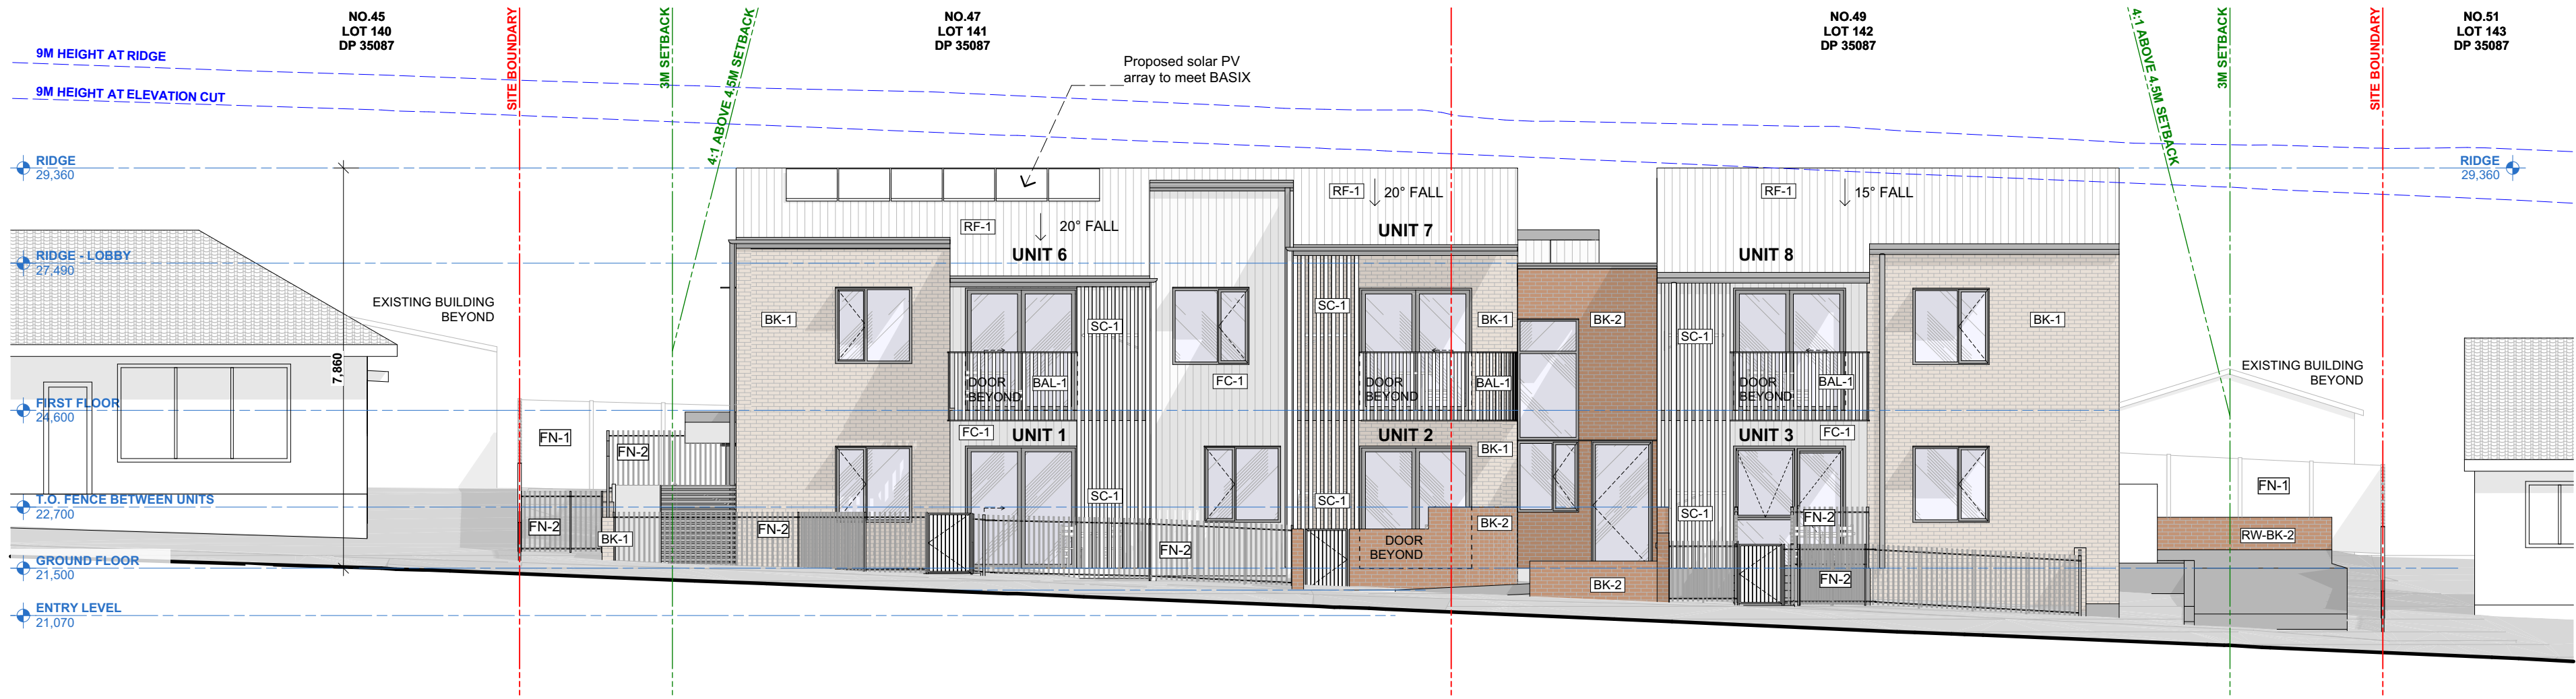
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PART 5 ASSESSMENT


STREET ELEVATIONS



*Chen*







EXTERNAL FINISHES	
BAL-1	BALUSTRADE METAL BALUSTRADE IN LEXICON QUARTER
BK-1	WALLS BRICK - PGH COASTAL HAMPTONS - GULL GREY
BK-2	WALLS BRICK - PGH TOWNHOUSE - KENT
FC-1	WALLS FIBRE CEMENT CLADDING - JAMES HARDIE AXON CLADDING SMOOTH 133
RW-BK	RETAINING WALL CONCRETE BLOCKWORK - WITH FACE BRICK BK-1 OR BK-2 (REFER ELEVATIONS)
FN-1	FENCING COLORBOND FENCE 1800mm (REFER LANDSCAPE DOCS.)
FN-2	FENCING KOHL PALISADE FENCING 1200mm (REFER LANDSCAPE DOCS.)
FN-3	FENCING KOHL PALISADE FENCING 800mm (REFER LANDSCAPE DOCS.)
SC-1	SCREENS ALUMINIUM VERTICAL BATTENS
RF-1	ROOF CORRUGATED METAL ROOF - LYSAGHT CUSTOM ORB SHALE GREY
MC-1	METAL CLADDING FINISH TO BE IN SHALE GREY
	WINDOWS AND DOORS ALUMINIUM FRAME
	FASCIA, GUTTER, DOWNPIPE, WINDOW HOODS FINISH TO BE IN SHALE GREY. LEXICON QUARTER FINISH FOR DOWNPIPES ADJACENT SC-1 (REFER ELEVATIONS)

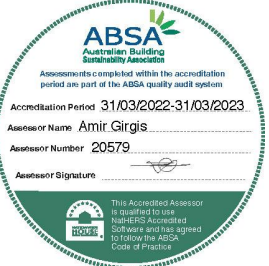



*Glenn*

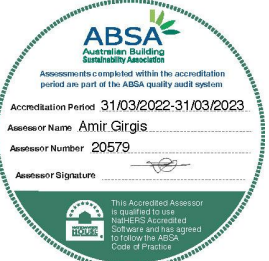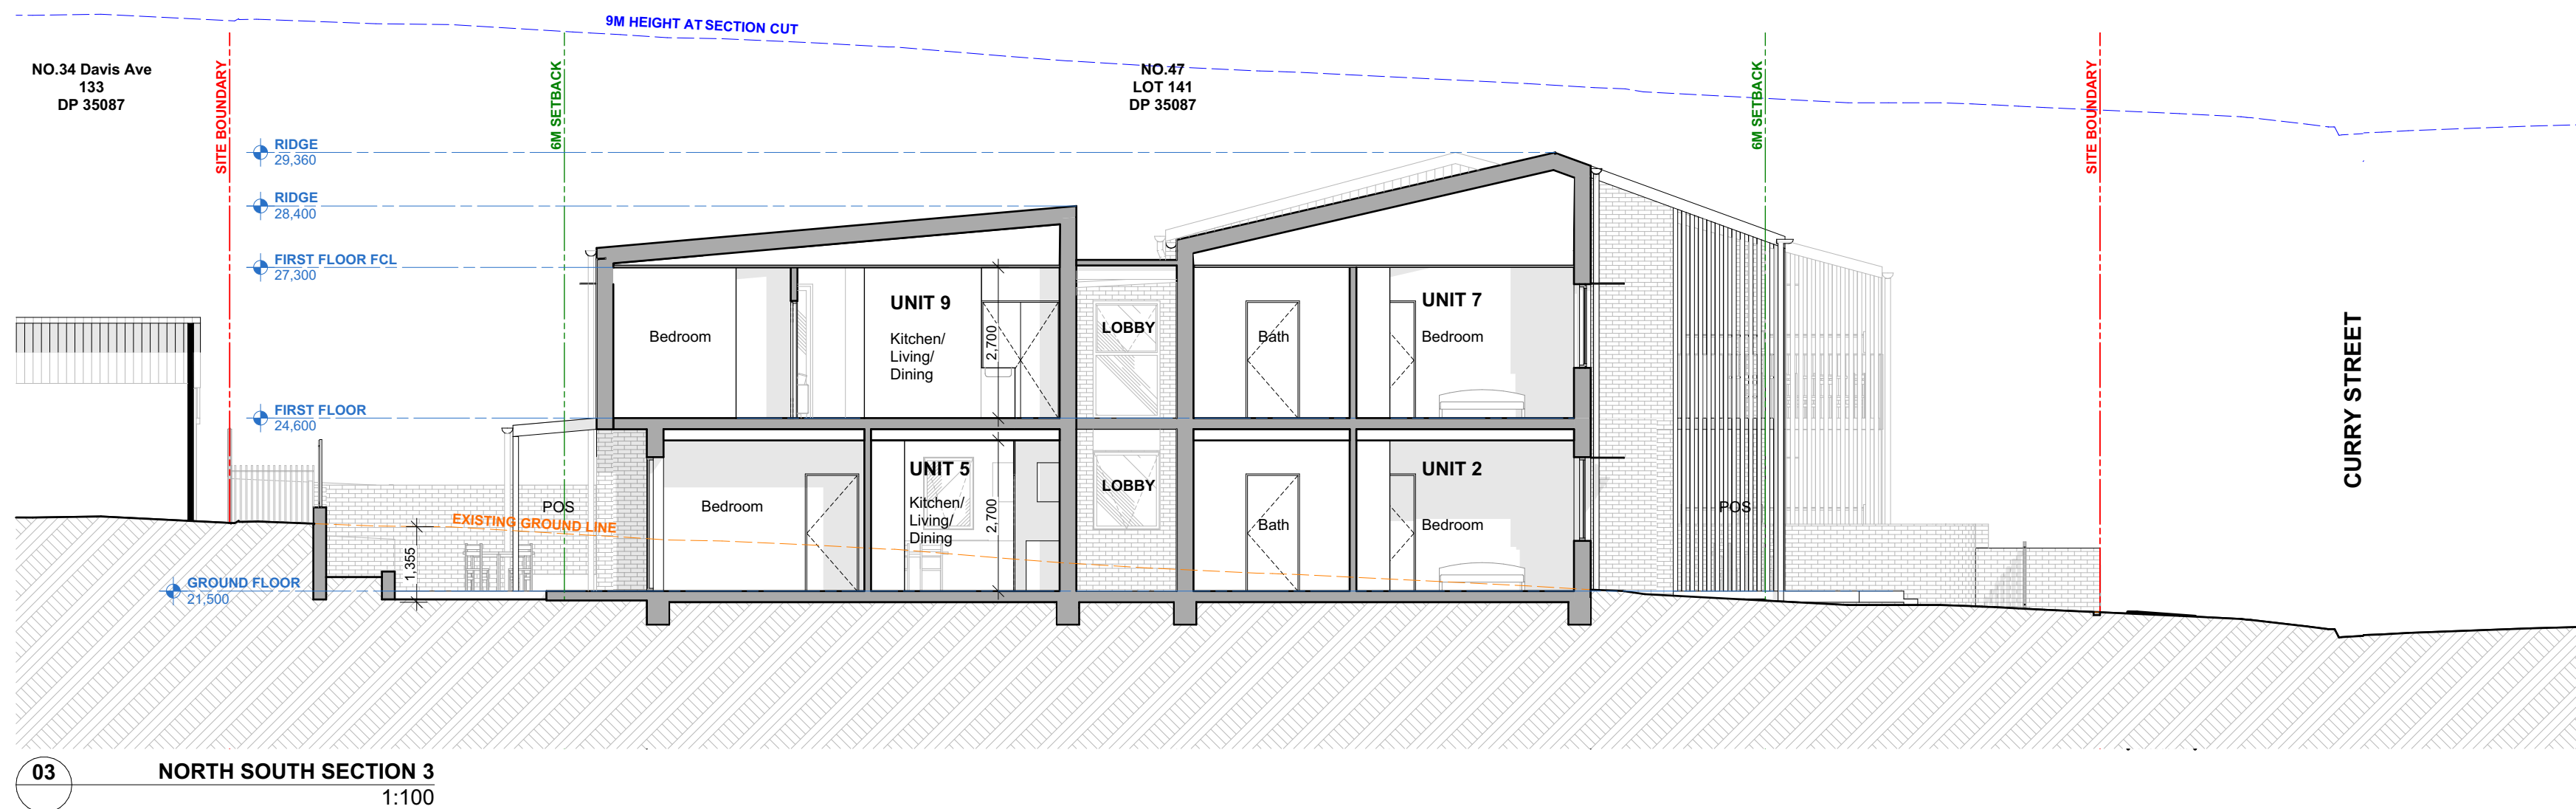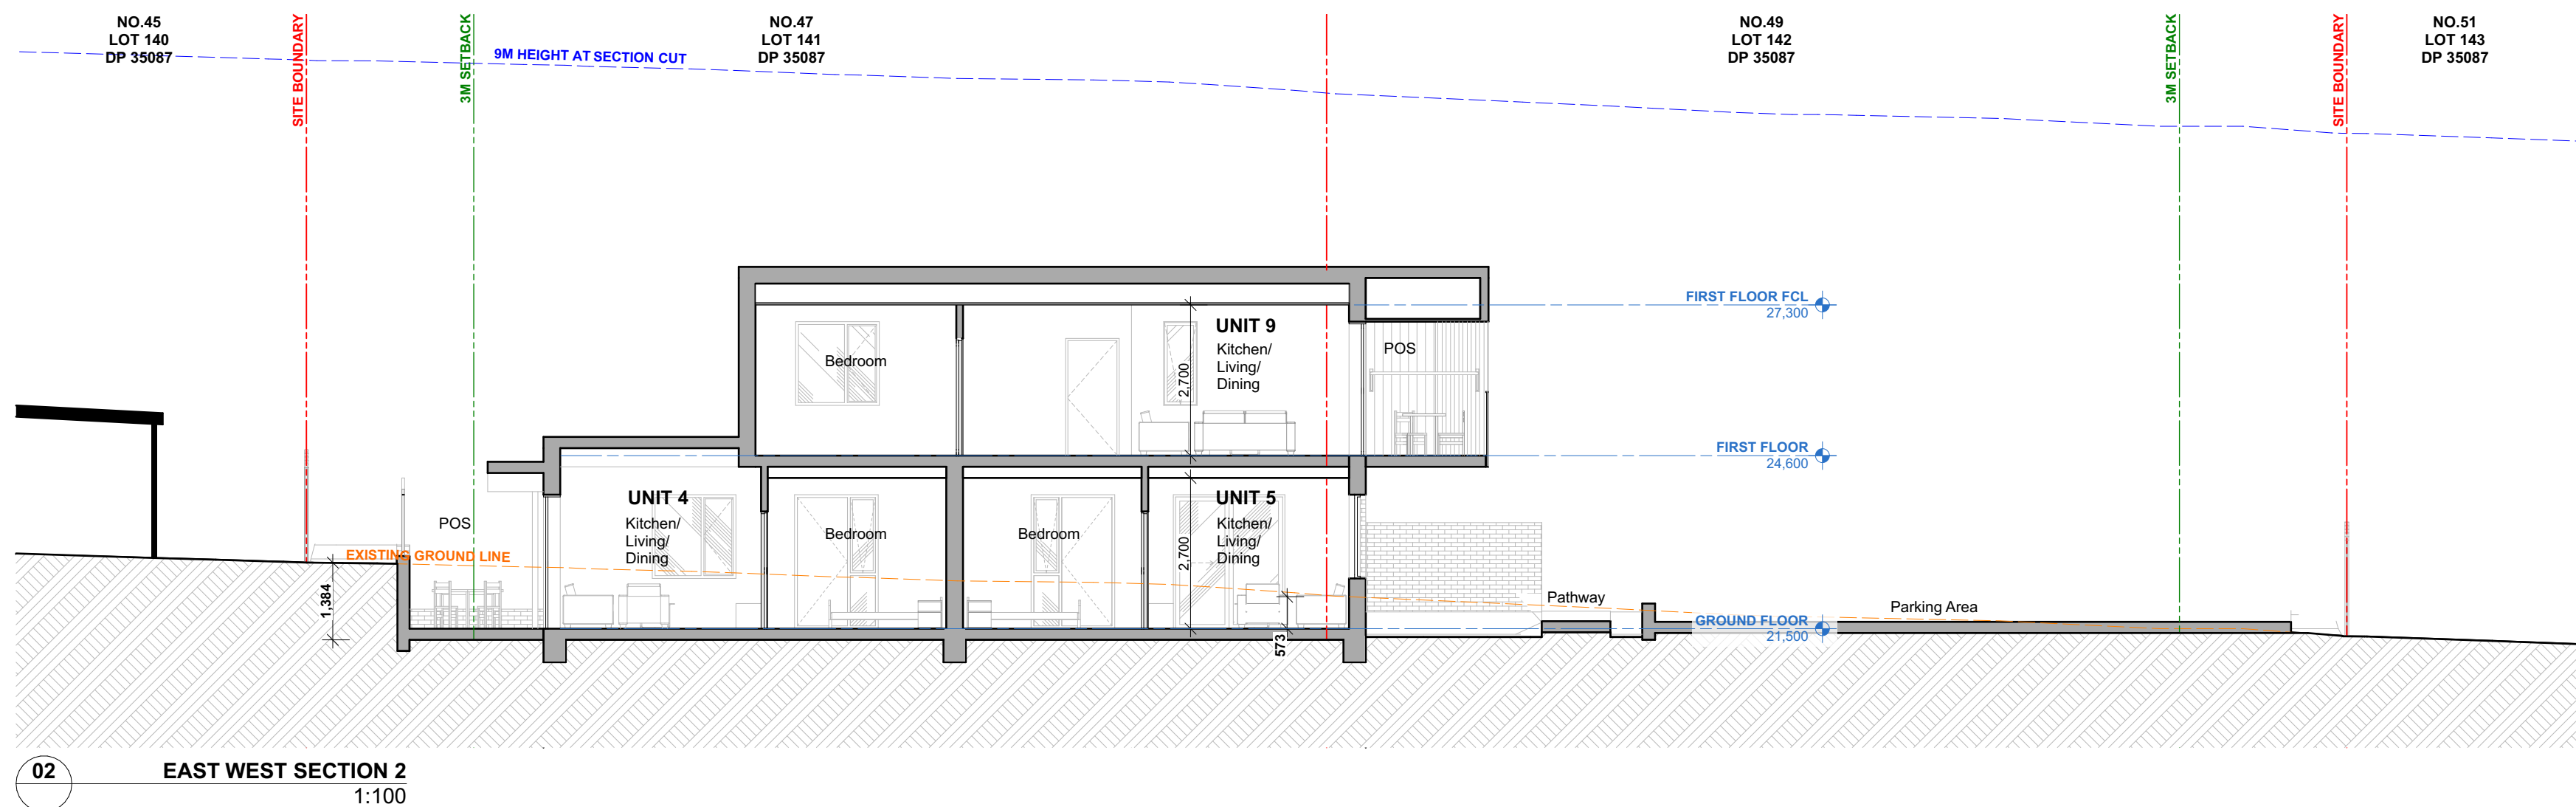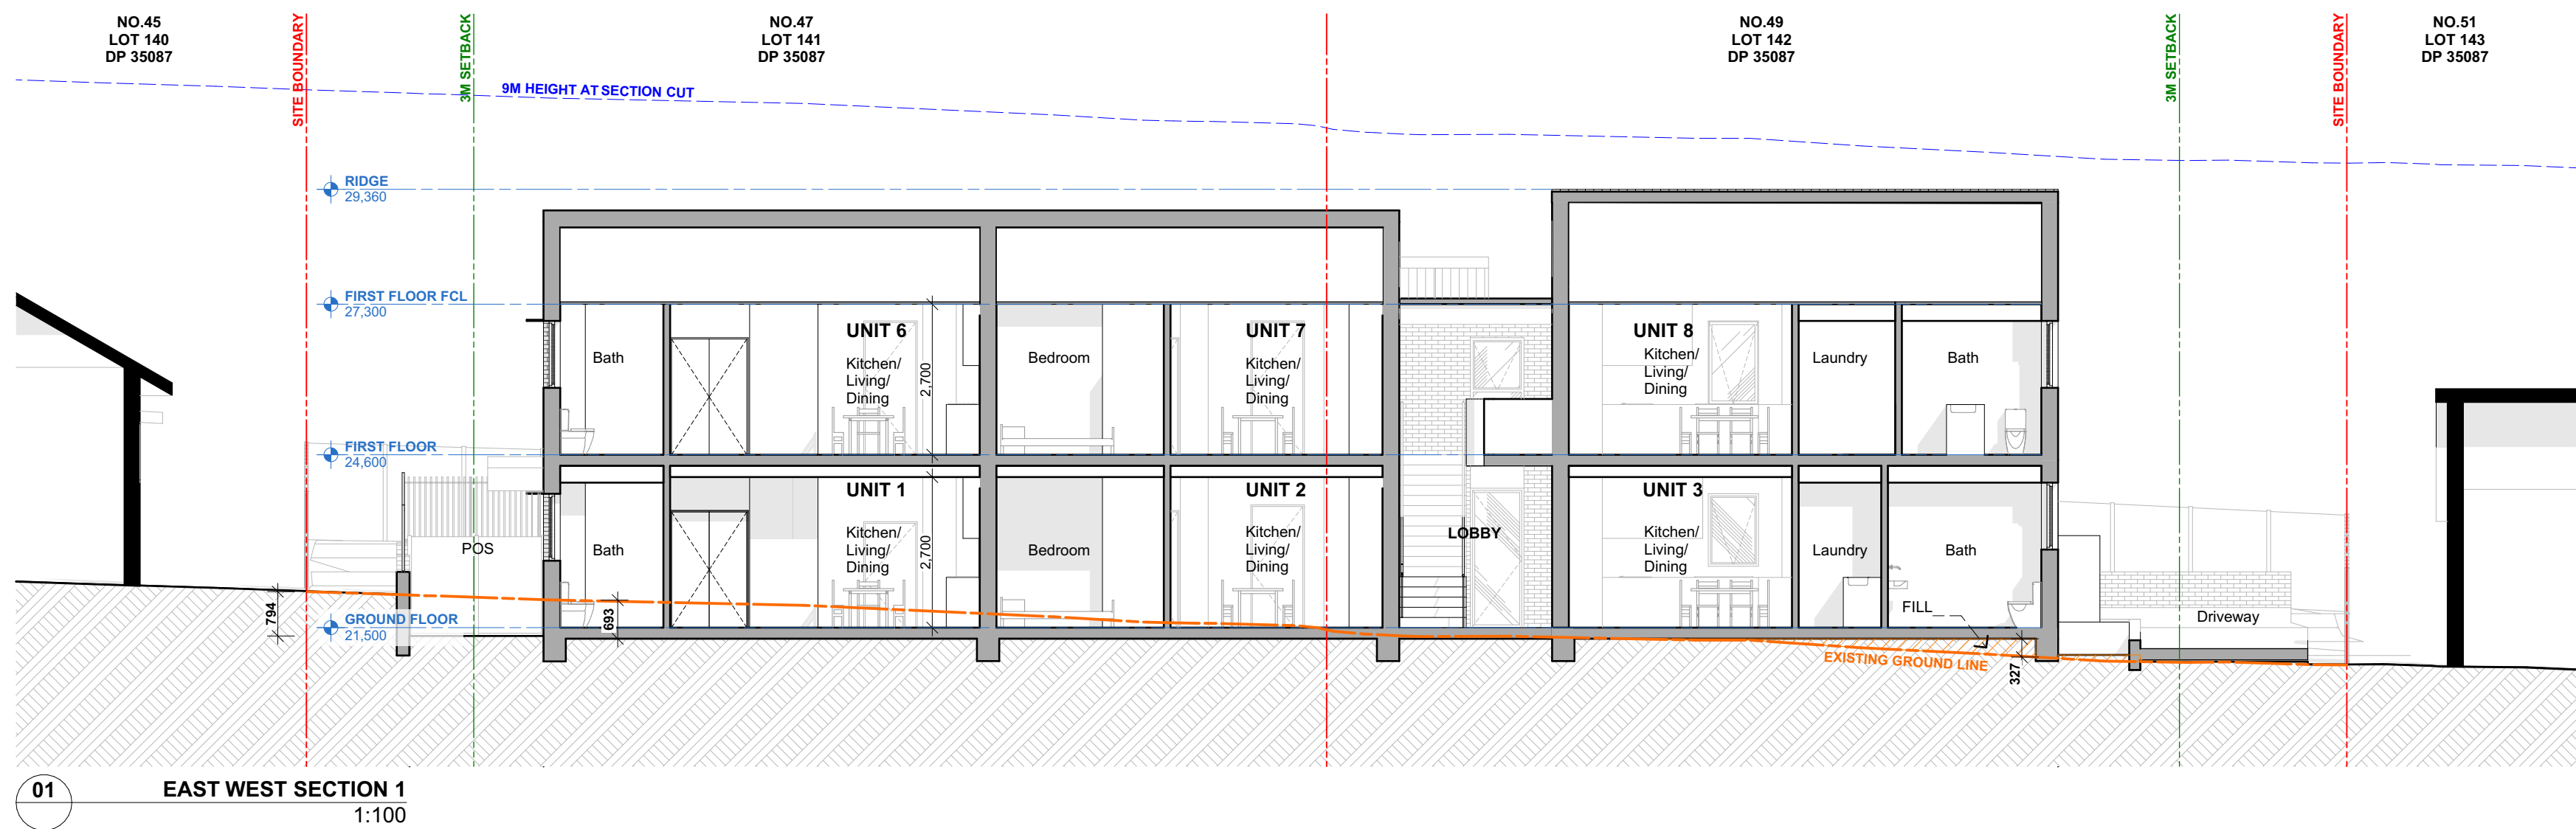

BAL	BALUSTRADE	FFL	FINISHED FLOOR LEVEL	MS	MESH SCREENING	TOW	TOP OF WALL
BR	BRICK	FI	FIRE INDICATOR PANEL	MSB	MAIN SWITCH BOARD	TOF	TOP OF FENCE
CL	CLOTHESLINE	FN	FENCING	NBN	NBN CUPBOARD	RL	REDUCED LEVEL
DP	DOWNPIPE	GD	GRATED DRAIN	NGL	NATURAL GROUND LEVEL	RF	ROOFING
EG	EAVES OUTTER	GM	GAS METER	O	OVEN	RW	RETAINING WALL
F	FROGE	HWU	HOT WATER UNIT	OSD	ON SITE DETENTION	RWT	RAIN WATER TANK
FC	FIBRE CEMENT CLADDING	LY	LAUNDRY	P	PANTRY	SWP	STORM WATER PIT
		LN	LINEN CUPBOARD	POS	PRIVATE OPEN SPACE	WM	WATER METER

BOUNDARY	SETBACKS	DEMOLITION	SUBSTATION EASEMENT	SUBSTATION 3M CLEARANCE
BOUNDARY	SETBACKS	DEMOLITION	SUBSTATION EASEMENT	SUBSTATION 3M CLEARANCE

TREE PROTECTION ZONE	VEHICULAR SIGHTLINES	ACCESSIBLE CLEARANCES	RL EXISTING	RL PROPOSED
TREE PROTECTION ZONE	VEHICULAR SIGHTLINES	ACCESSIBLE CLEARANCES	RL EXISTING	RL PROPOSED

70% DA FOR LAHC REVIEW	AND SUBMISSION	AND RESUBMISSION
70% DA FOR LAHC REVIEW	AND SUBMISSION	AND RESUBMISSION

REV	APPRO	DATE	CLIENT
P1	SC	4/02/2022	LAND & HOUSING CORPORATION (LAHC)
P2	SC	8/03/2022	PROJECT
P3	SC	12/04/2022	PROJECT

SCALE @ A1	SCALE @ A3	PROJECT NO.	STAGE	DRAWING NO.	REV
1:100	1:200	21.25	AA	301	P3

DESCRIPTION	70% DA FOR LAHC REVIEW	AND SUBMISSION	AND RESUBMISSION
DESCRIPTION	70% DA FOR LAHC REVIEW	AND SUBMISSION	AND RESUBMISSION

EMAIL	studio@samcrawfordarchitects.com.au	WEB	samcrawfordarchitects.com.au
EMAIL	studio@samcrawfordarchitects.com.au	WEB	samcrawfordarchitects.com.au

ACN	165 400 587	Nominated Architect	Sam Crawford 6498
ACN	165 400 587	Nominated Architect	Sam Crawford 6498

70% DA FOR LAHC REVIEW	AND SUBMISSION	AND RESUBMISSION
70% DA FOR LAHC REVIEW	AND SUBMISSION	AND RESUBMISSION

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70% DA FOR LAHC REVIEW	AND SUBMISSION	AND RESUBMISSION

70% DA FOR LAHC REVIEW	AND SUBMISSION	AND RESUBMISSION
70% DA FOR LAHC REVIEW	AND SUBMISSION	AND RESUBMISSION

PART 5 ASSESSMENT



SECTIONS



*John*


C U R R Y   S T R E E T

C U R R Y   S T R E E T

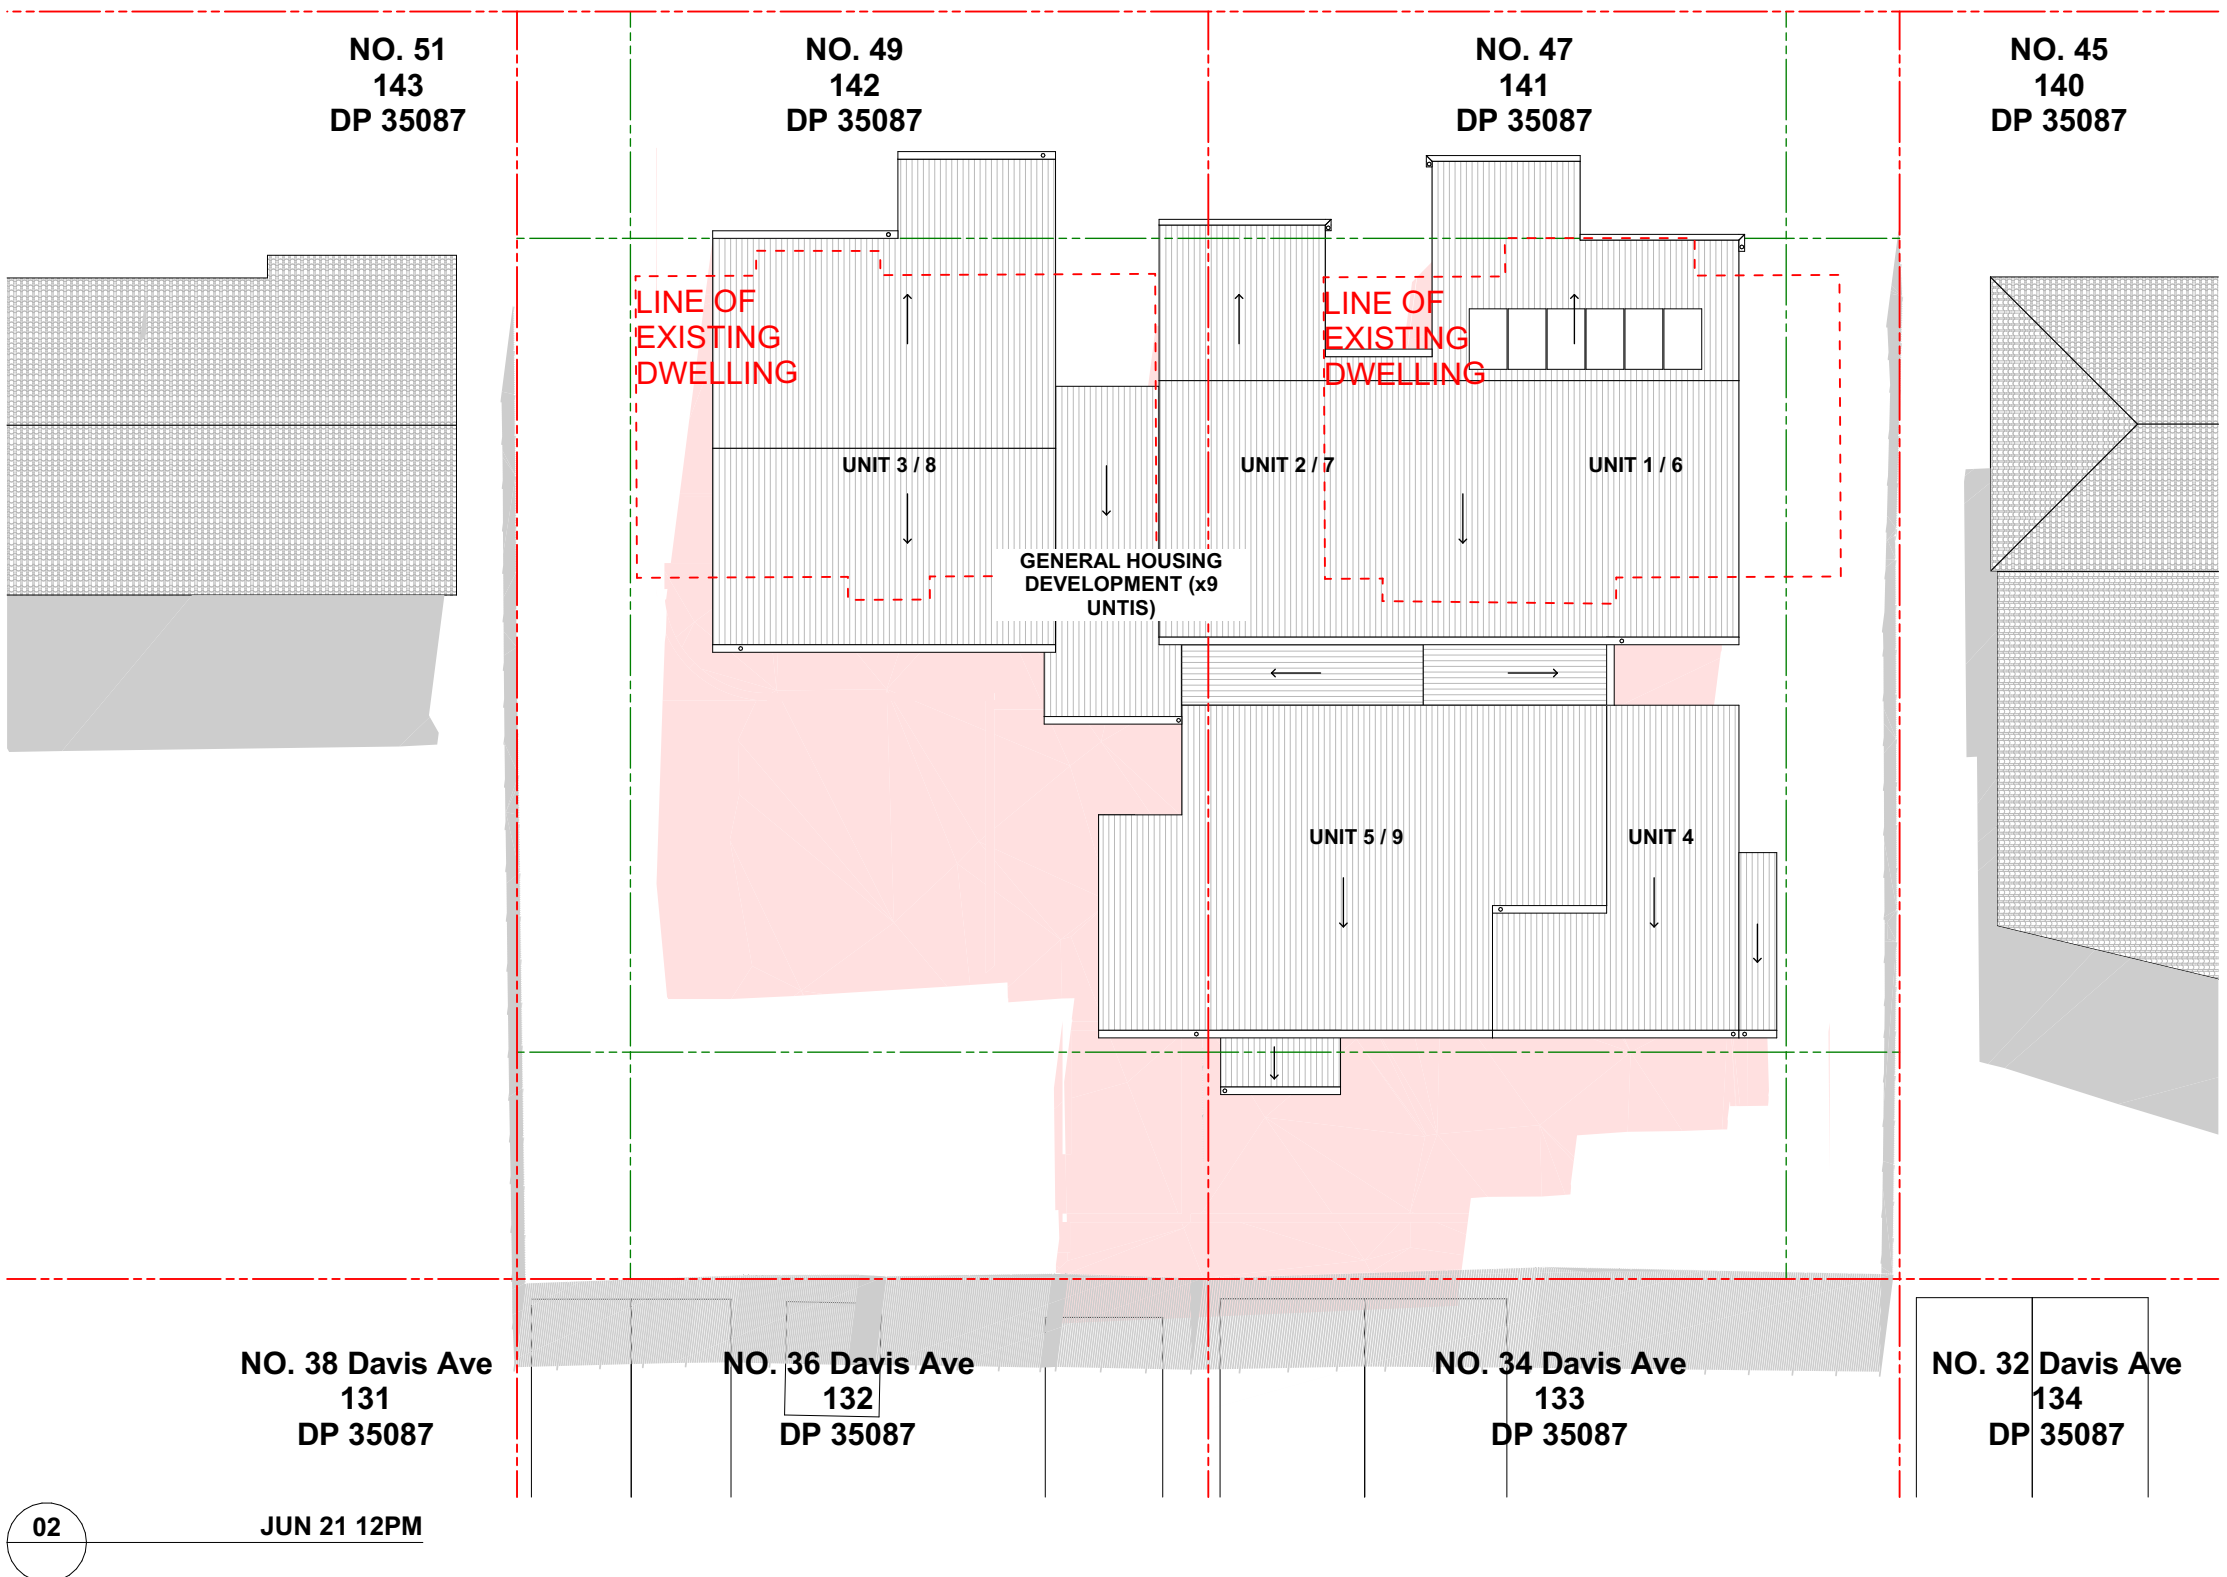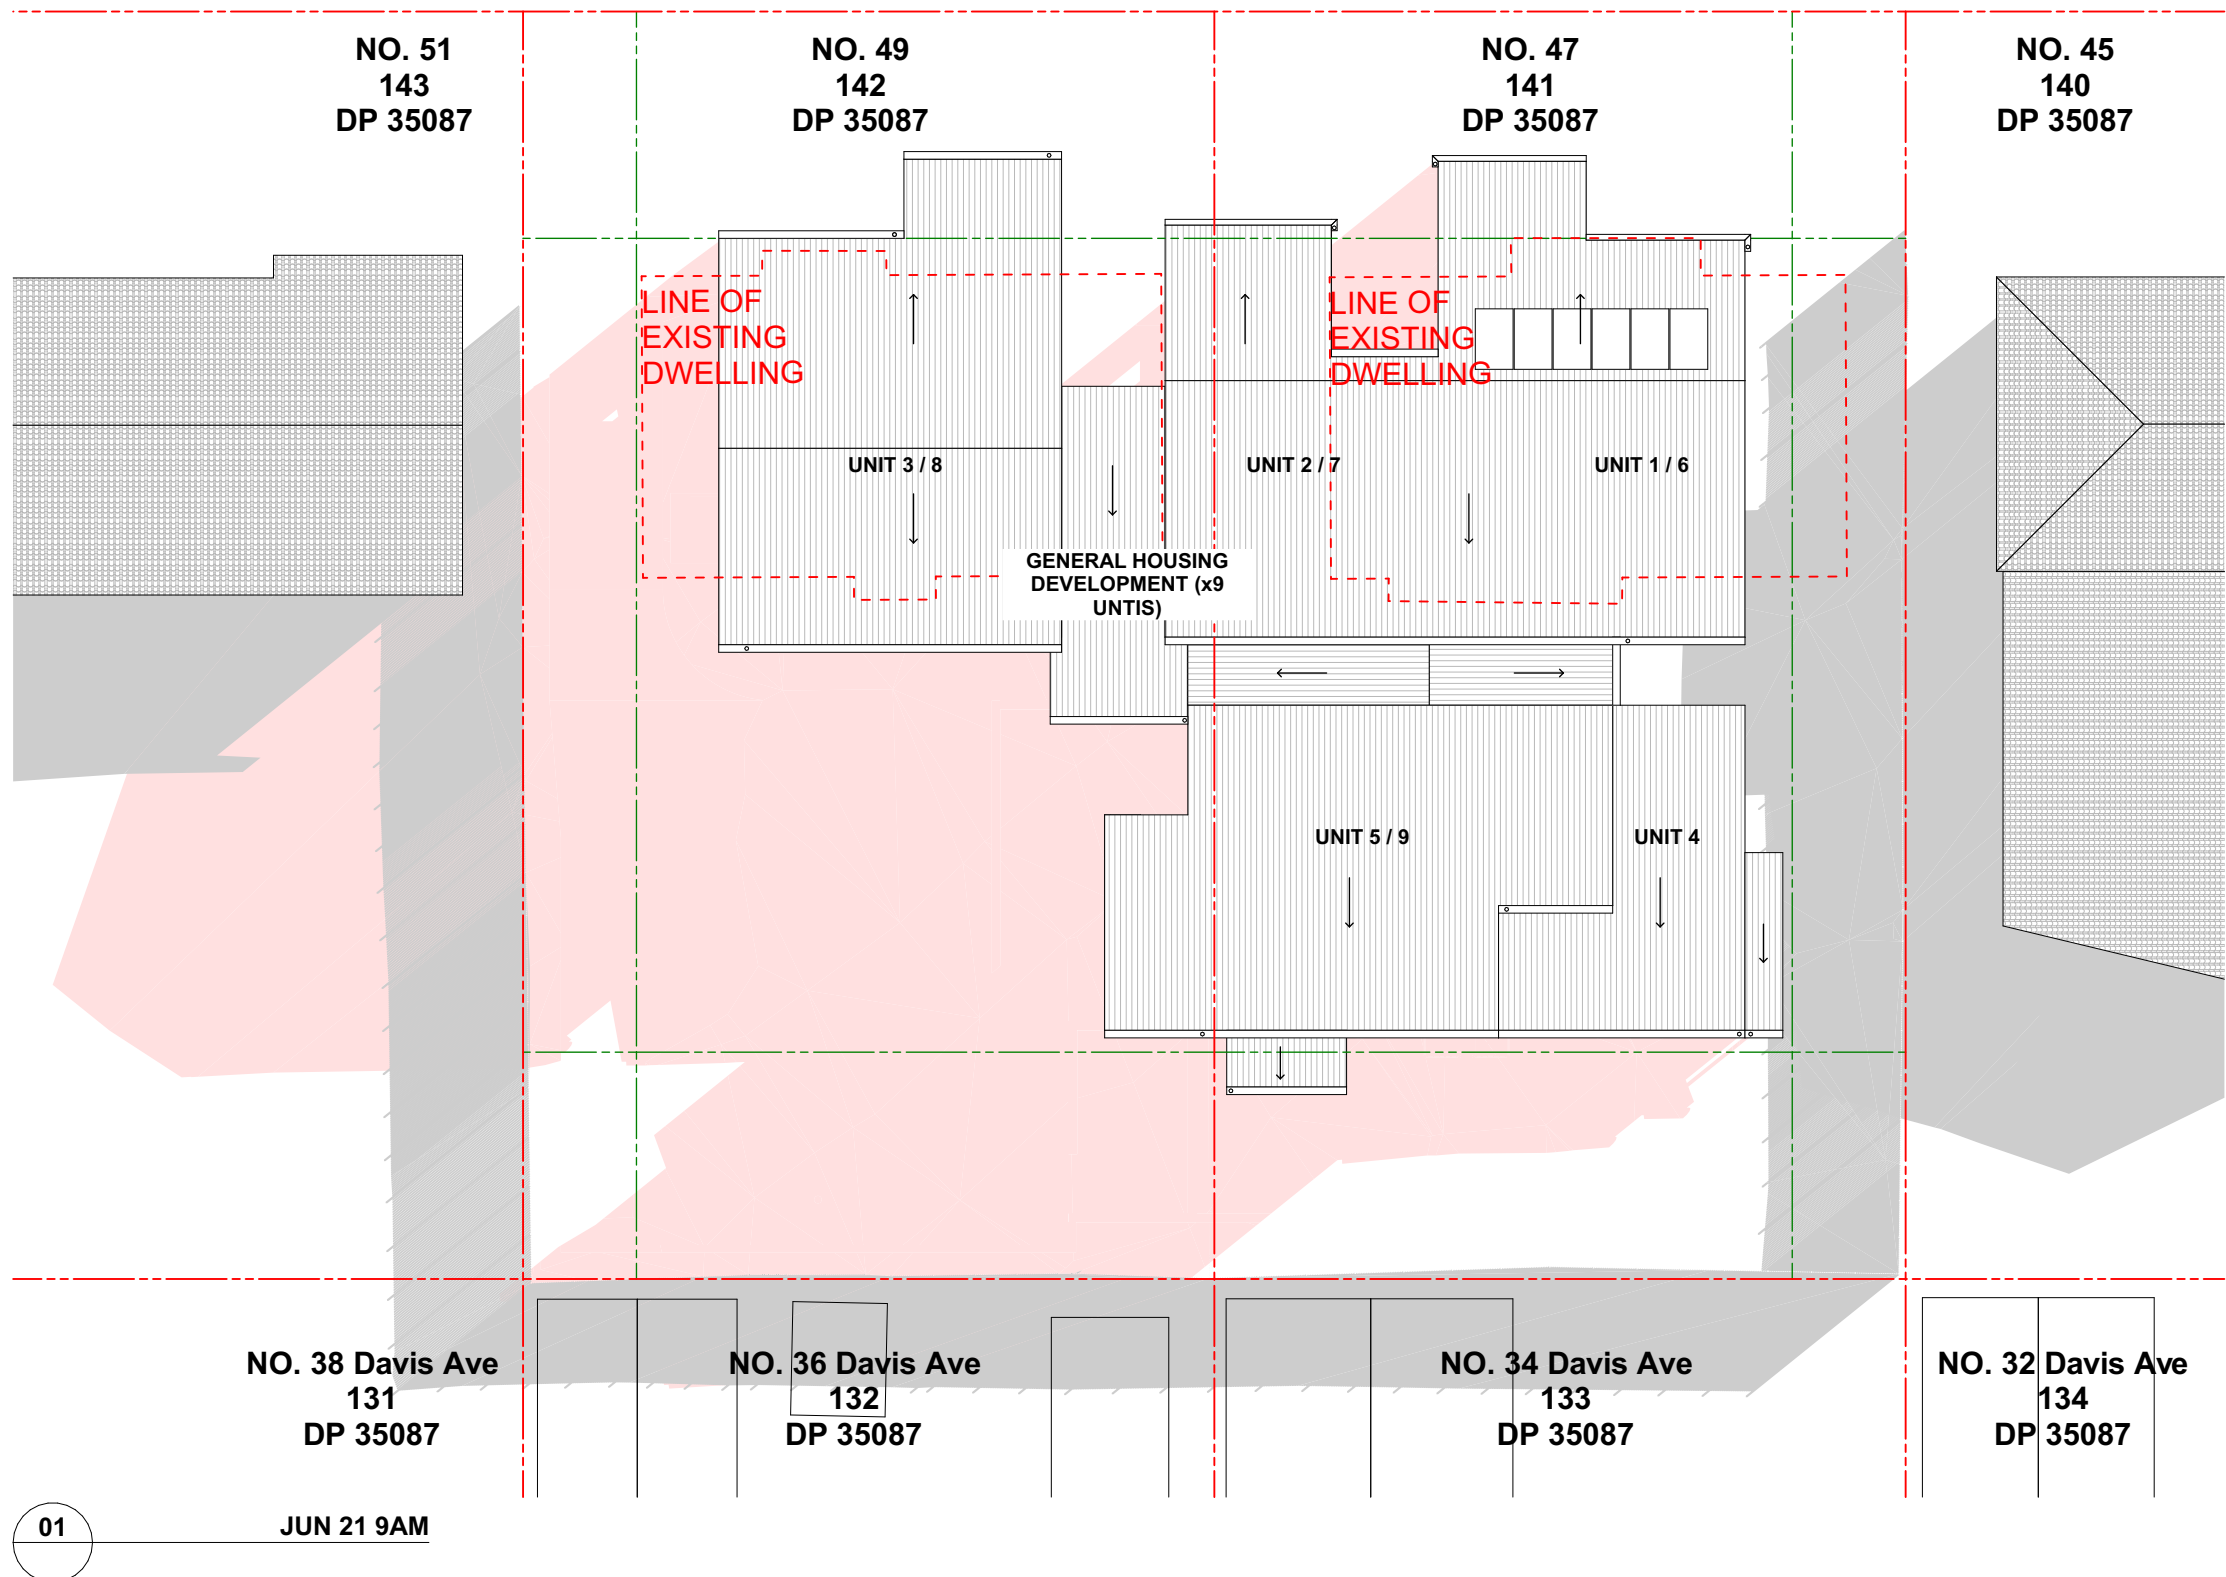

C U R R Y   S T R E E T

**LEGEND**  
SHADOWS CAST BY NEIGHBOURS  
SHADOWS CAST BY PROPOSED DWELLING

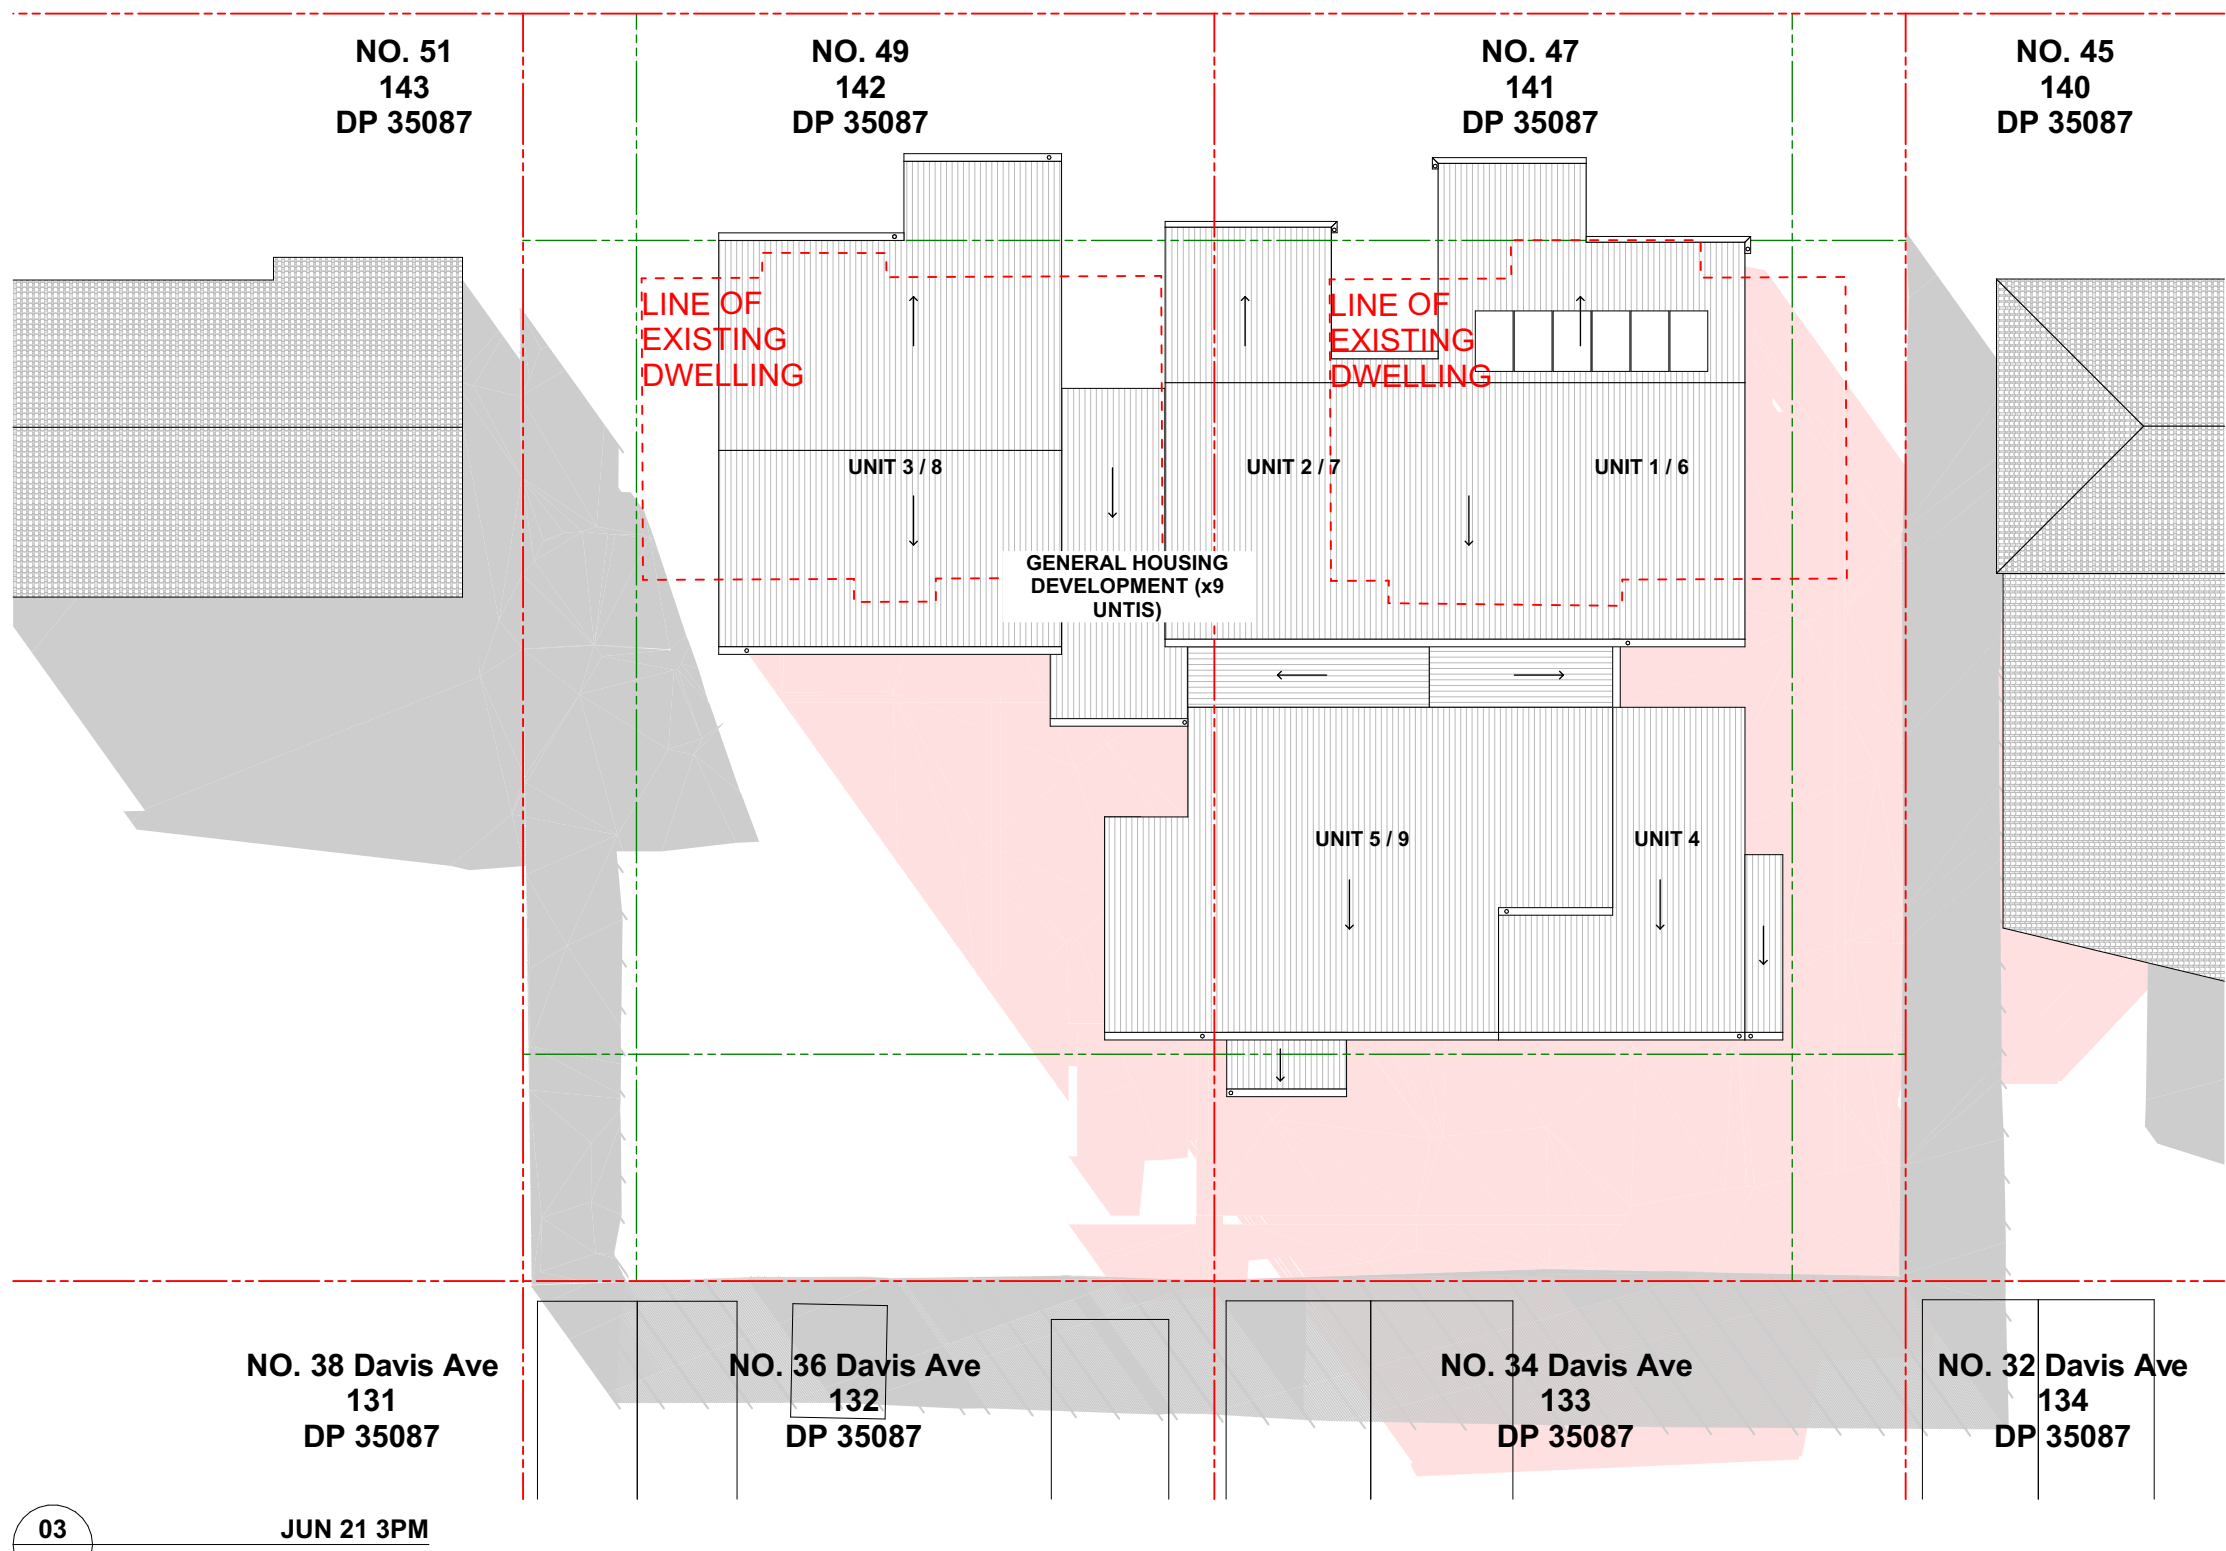

BAL	BALUSTRADE	FFL	FINISHED FLOOR LEVEL	MS	MESH SCREENING	TOW	TOP OF WALL
BR	BRICK	FI	FIRE INDICATOR PANEL	MSB	MAIN SWITCH BOARD	TOF	TOP OF FENCE
CL	CLOTHESLINE	FN	FENCING	NBN	NBN CUPBOARD	RL	REDUCED LEVEL
DP	DOWNSPIPE	GD	GRATED DRAIN	NGL	NATURAL GROUND LEVEL	RF	ROOFING
EG	EAVES OUTTER	GM	GAS METER	O	OVEN	RL	RETAINING WALL
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		LN	LINEN CUPBOARD	POS	PRIVATE OPEN SPACE	WM	WATER METER

MS	MESH SCREENING	TOW	TOP OF WALL
MSB	MAIN SWITCH BOARD	TOF	TOP OF FENCE
NBN	NBN CUPBOARD	RL	REDUCED LEVEL
NGL	NATURAL GROUND LEVEL	RF	ROOFING
O	OVEN	RL	RETAINING WALL
OSD	ON SITE DETENTION	RWT	RAIN WATER TANK
P	PANTRY	SWP	STORM WATER PIT
POS	PRIVATE OPEN SPACE	WM	WATER METER

BOUNDARY	SETBACKS	TREE PROTECTION ZONE
DEMOLITION	ACCESSIBLE CLEARANCES	VEHICULAR SIGHTLINES
SUBSTATION EASEMENT	RL EXISTING	RL PROPOSED
SUBSTATION 3M CLEARANCE		

BOUNDARY	SETBACKS	TREE PROTECTION ZONE
DEMOLITION	ACCESSIBLE CLEARANCES	VEHICULAR SIGHTLINES
SUBSTATION EASEMENT	RL EXISTING	RL PROPOSED
SUBSTATION 3M CLEARANCE		

PART 5 ASSESSMENT

SHADOW DIAGRAMS




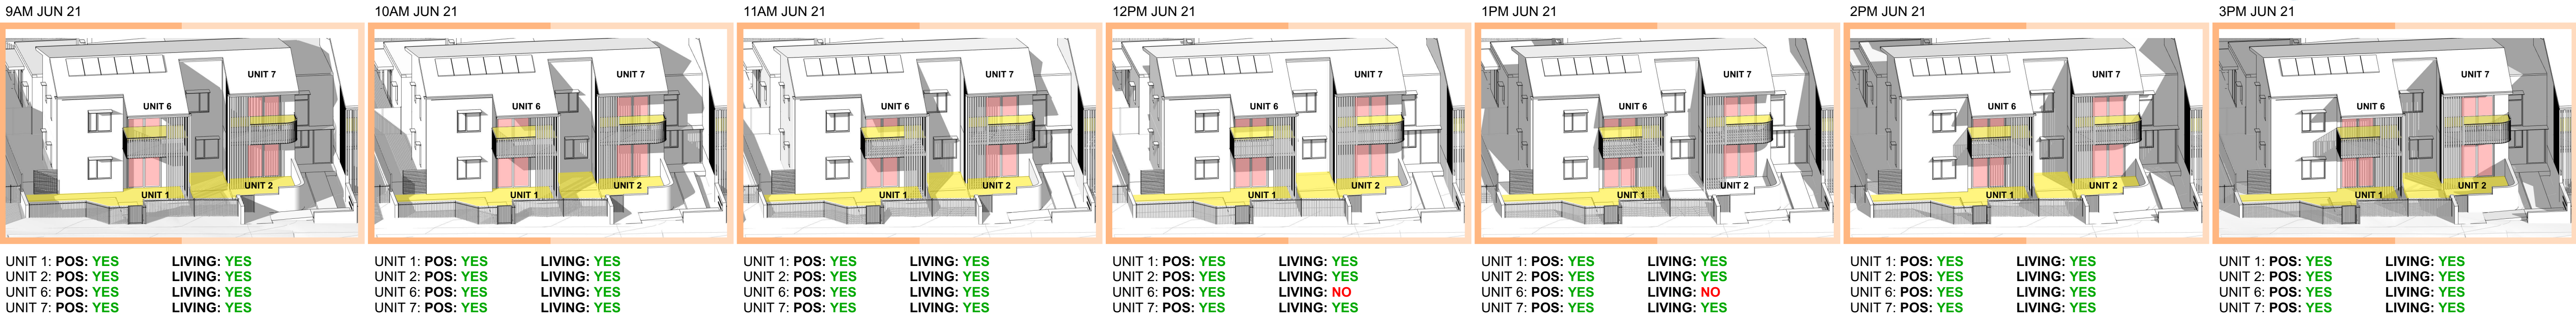


01 UNIT 1, 2, 6, 7

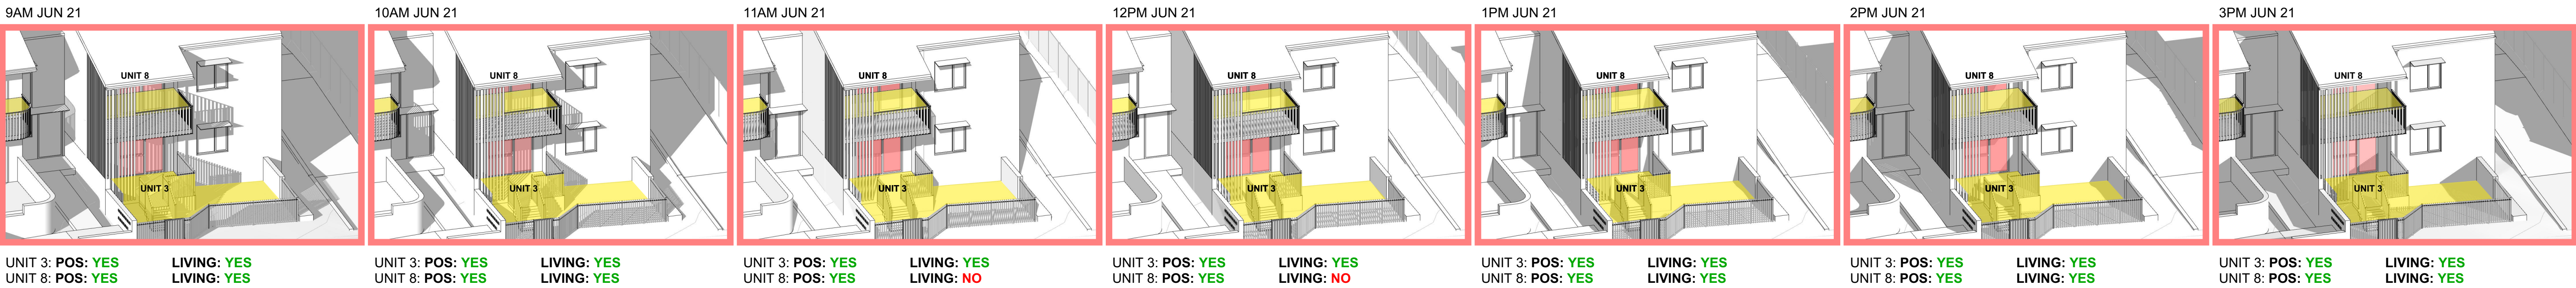

02 UNIT 3, 8

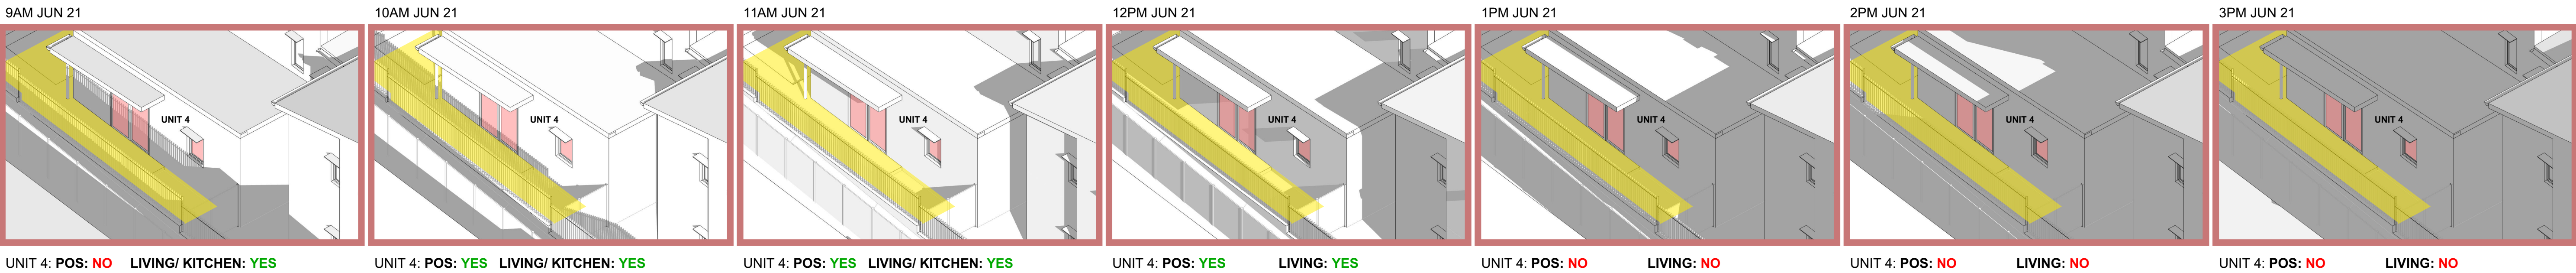



03 9AM UNIT 4

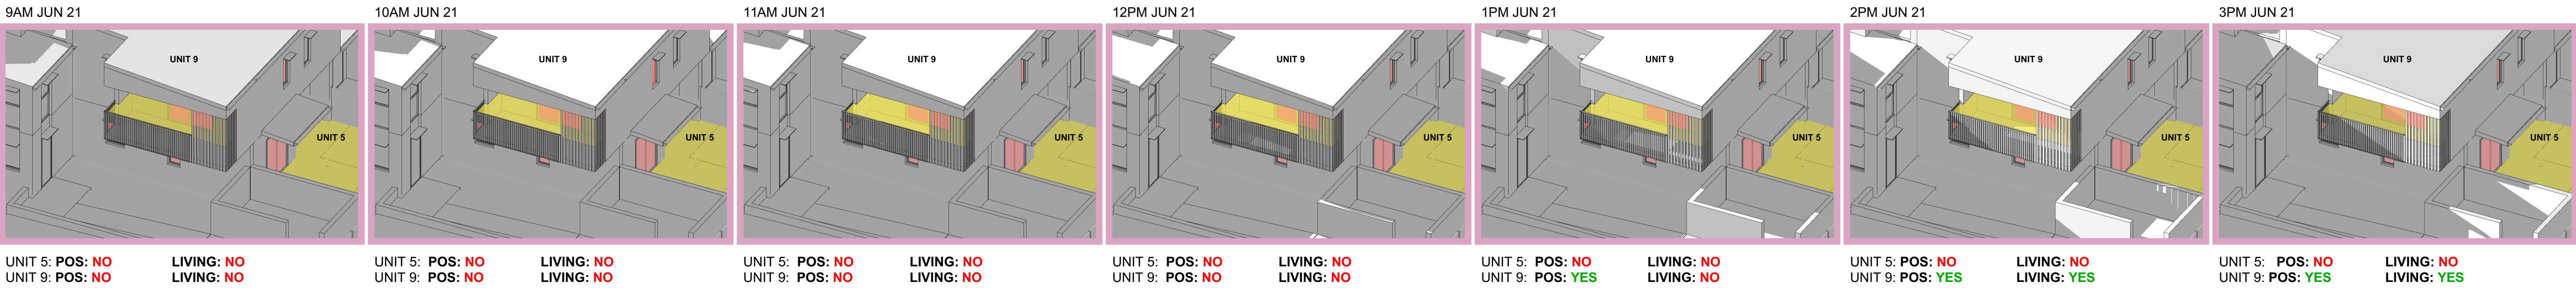

04 UNIT 5, 9

SENIORS LIVING URBAN DESIGN GUIDE OBJECTIVE 5

UNIT 1:	3HR minimum (9AM-3PM) Midwinter	POS: YES	LIVING: YES
UNIT 2:	3HR minimum (9AM-3PM) Midwinter	POS: YES	LIVING: YES
UNIT 3:	3HR minimum (9AM-3PM) Midwinter	POS: YES	LIVING: YES
UNIT 4:	3HR minimum (9AM-3PM) Midwinter	POS: YES	LIVING: YES
UNIT 5:	3HR minimum (9AM-3PM) Midwinter	POS: NO	LIVING: NO
UNIT 6:	3HR minimum (9AM-3PM) Midwinter	POS: YES	LIVING: YES
UNIT 7:	3HR minimum (9AM-3PM) Midwinter	POS: YES	LIVING: YES
UNIT 8:	3HR minimum (9AM-3PM) Midwinter	POS: YES	LIVING: YES
UNIT 9:	3HR minimum (9AM-3PM) Midwinter	POS: NO	LIVING: NO

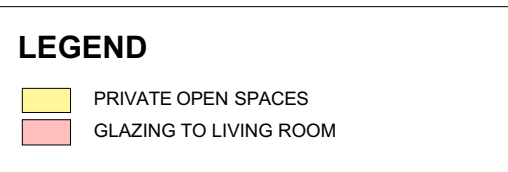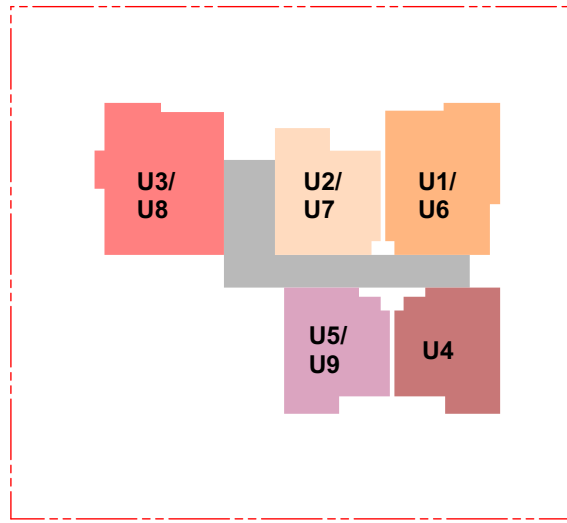

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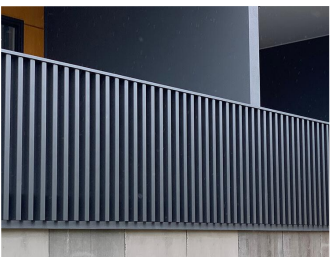
samcrawfordarchitects  
Unit 4, 30 Wilson Street, Australia NSW 2042  
EMAIL: studio@samcrawfordarchitects.com.au WEB: samcrawfordarchitects.com.au  
ACN: 165 405 587 Nominated Architect Sam Crawford 6488

DESCRIPTION  
70% DA FOR LAHC REVIEW  
AND SUBMISSION  
AND RESUBMISSION

REV	APPROVED	DATE	CLIENT
P1	SC	4/02/2022	LAND & HOUSING CORPORATION (LAHC)
P2	SC	8/03/2022	PROJECT
P3	SC	12/04/2022	CURRY ST 47-49 CURRY STREET, WALLSEND NSW 2287

SCALE @ A1	PROJECT NO.	STAGE	DRAWING NO.	REV
N.T.S.	21.25	AA	402	P3
SCALE @ A3	DRAWING TITLE			
N.T.S.	SOLAR ACCESS			






**BAL - 1**  
Aluminium batten balustrade  
in Lexicon Quarter or similar  
finish



**BK - 1**  
PGH Coastal Hamptons - Gull  
Grey



**BK - 2**  
PGH Townhouse - Kent

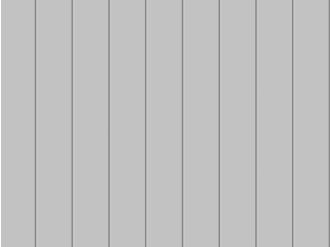

**FC - 1**  
James Hardie Axon Cladding  
- Smooth 133



**FN - 1**  
Colorbond steel fence in  
Monument grey



**FN - 2**  
Kohl Palisade Fencing




**MC - 1**  
Flat metal cladding in 'Shale  
Grey'



**RF - 1**  
Lysaght custom orb 0.42 BMT in 'Shale Grey'.  
Steel Columns, Fascia, Gutter, Downpipe to  
be in 'Shale Grey'. Downpipe adjacent to SC-1  
to be in Lexicon Quarter




**RW - BK**  
Concrete Blockwork Retaining  
Wall with face brick

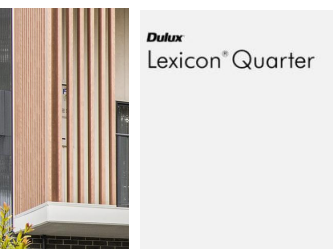

**SC-1**  
Aluminium batten privacy  
screen in Lexicon Quarter or  
similar finish



**HEKA HOODS**  
Over windows

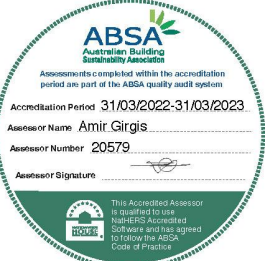

BAL	BALUSTRADE
BK	BRICK
CL	CLOTHESLINE
DP	DOWNPIPE
EG	EAVES OUTTER
F	FIBRE CEMENT CLADDING
FC	FIBRE CEMENT CLADDING

FFL	FINISHED FLOOR LEVEL
FP	FIRE INDICATOR PANEL
FN	FENCING
GD	GRATED DRAIN
GM	GAS METER
HWU	HOT WATER UNIT
LY	LAUNDRY
LN	LINEN CUPBOARD

MS	MESH SCREENING
MSB	MAIN SWITCH BOARD
NBN	NBN CUPBOARD
NGL	NATURAL GROUND LEVEL
O	OVEN
OSD	ON SITE DETENTION
P	PANTRY
POS	PRIVATE OPEN SPACE

TOW	TOP OF WALL
TOF	TOP OF FENCE
RL	REDUCED LEVEL
RF	ROOFING
RW	RETAINING WALL
RWT	RAIN WATER TANK
SWP	STORM WATER PIT
WM	WATER METER

BOUNDARY	BOUNDARY
SETBACKS	SETBACKS
DEMOLITION	DEMOLITION
SUBSTATION EASEMENT	SUBSTATION EASEMENT
SUBSTATION 3M CLEARANCE	SUBSTATION 3M CLEARANCE

TREE PROTECTION ZONE	TREE PROTECTION ZONE
VEHICULAR SIGHTLINES	VEHICULAR SIGHTLINES
ACCESSIBLE CLEARANCES	ACCESSIBLE CLEARANCES
RL EXISTING	RL EXISTING
RL PROPOSED	RL PROPOSED

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AND RESUBMISSION	AND RESUBMISSION

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ACN 165 405 587 Nominated Architect Sam Crawford 6498	ACN 165 405 587 Nominated Architect Sam Crawford 6498

DESCRIPTION	DESCRIPTION
70% DA FOR LAHC REVIEW	70% DA FOR LAHC REVIEW
AND SUBMISSION	AND SUBMISSION
AND RESUBMISSION	AND RESUBMISSION

REV	REV
P1	P1
SC	SC
P2	P2
SC	SC
P3	P3
SC	SC

APPD	APPD
4/02/2022	4/02/2022
8/03/2022	8/03/2022
12/04/2022	12/04/2022

CLIENT	CLIENT
LAND & HOUSING CORPORATION (LAHC)	LAND & HOUSING CORPORATION (LAHC)
PROJECT	PROJECT
CURRY ST	CURRY ST
47-49 CURRY STREET, WALLSEND NSW 2287	47-49 CURRY STREET, WALLSEND NSW 2287

SCALE @ A1	SCALE @ A1
N.T.S.	N.T.S.
SCALE @ A3	SCALE @ A3
N.T.S.	N.T.S.

PROJECT NO.	PROJECT NO.
21.25	21.25
STAGE	STAGE
AA	AA
DRAWING NO.	DRAWING NO.
501	501
REV	REV
P3	P3

DRAWING TITLE	DRAWING TITLE
EXT. FINISHES & MATERIALS	EXT. FINISHES & MATERIALS

SCALE @ A1	SCALE @ A1
N.T.S.	N.T.S.
SCALE @ A3	SCALE @ A3
N.T.S.	N.T.S.

PROJECT NO.	PROJECT NO.
21.25	21.25
STAGE	STAGE
AA	AA
DRAWING NO.	DRAWING NO.
501	501
REV	REV
P3	P3

DRAWING TITLE	DRAWING TITLE
EXT. FINISHES & MATERIALS	EXT. FINISHES & MATERIALS

SCALE @ A1	SCALE @ A1
N.T.S.	N.T.S.
SCALE @ A3	SCALE @ A3
N.T.S.	N.T.S.

PROJECT NO.	PROJECT NO.
21.25	21.25
STAGE	STAGE
AA	AA
DRAWING NO.	DRAWING NO.
501	501
REV	REV
P3	P3

DRAWING TITLE	DRAWING TITLE
EXT. FINISHES & MATERIALS	EXT. FINISHES & MATERIALS



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design  
group.

sam  
crawford  
architects



## LAHC WALLSEND - CURRY STREET

Prepared for

NSW LAND AND HOUSING  
CORPORATION

June 2022



# Contents

Extent of Works	03
Landscape Plan	04
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Material Schedule	08
Typical landscape details	09



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Report title	47 - 49 Curry Street, Wallsend NSW 2287
Document number	2521028
Prepared for	Sam Crawford Architects
Authors	Georgia McDonald, Caleb Wright
Revision number	05
Revision issue date	23/06/2022
Approved	Nick Ison
Reason for revision	LAHC Comments

Disclaimer: This report has been prepared in accordance with the scope of services described in the contract or agreement between Place Design Group Pty Ltd ACN 082 370063 and the Client. The report relies upon data, surveys, measurements and results taken at or under the particular times and conditions specified herein. Any findings, conclusions or recommendations only apply to the aforementioned circumstances and no greater reliance should be assumed or drawn by the Client. Furthermore, the report has been prepared solely for use by the Client and Place Design Group accepts no responsibility for its use by other parties.

EXTENT OF WORKS

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8 March 2023

*[Signature]*



 Extent of works



# LANDSCAPE PLAN

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8 March 2023

Check.

**LEGEND:**

- Extent of works

Planting Mix 1

Planting Mix 2

Storm water pit

Paver to courtyard

*Syzygium australe*

*Melaleuca* 'Claret Tops'

*Callistemon viminalis*


*Callistemon* 'White Anzac'

*Myoporum parvifolium* (around substation)

Note: refer to page 6 for information on tree species. Mass planting not to obstruct path of gates.


NOTES:

- 01 Feature tree to frontage entry
- 02 2m high hedging along site boundary for privacy
- 03 OSD and rainwater tank below
- 04 Shade tolerant low planting
- 05 Paved private open space
- 06 New bin store location
- 07 Screen hedging to car park
- 08 Tree to boundary (Screening)
- 09 Potential substation location
- 10 Existing trees to be retained

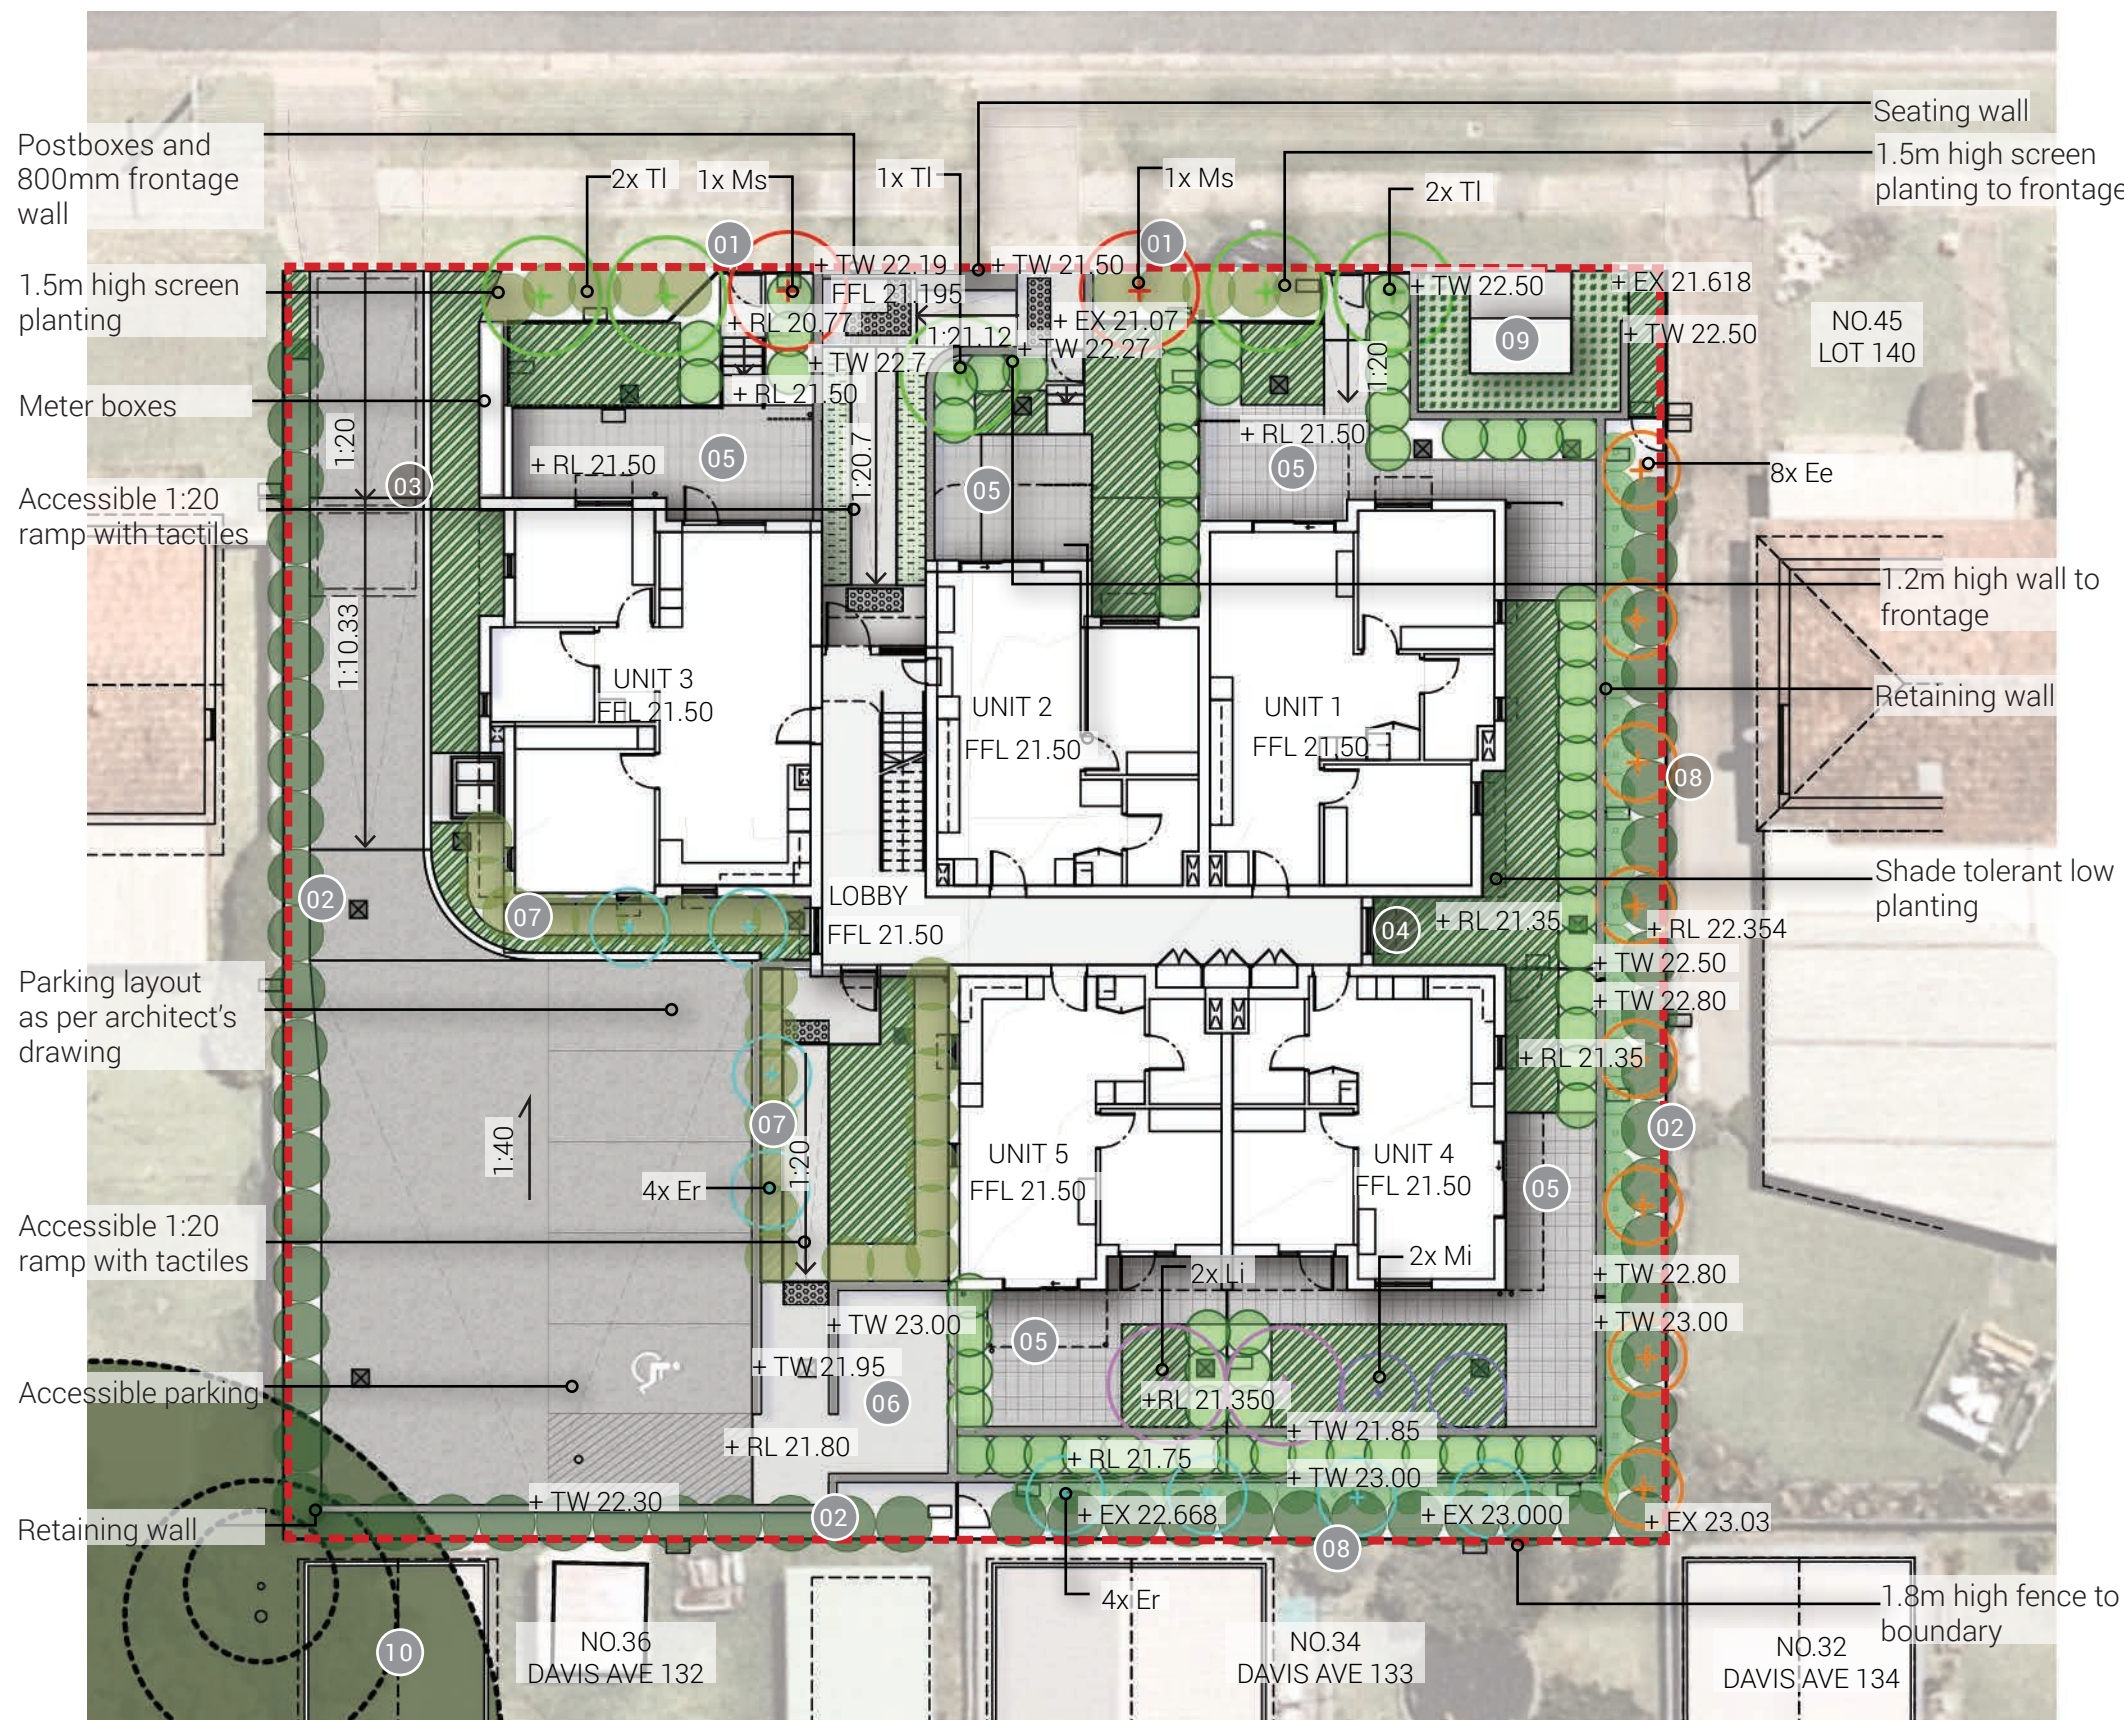



*[Signature]*

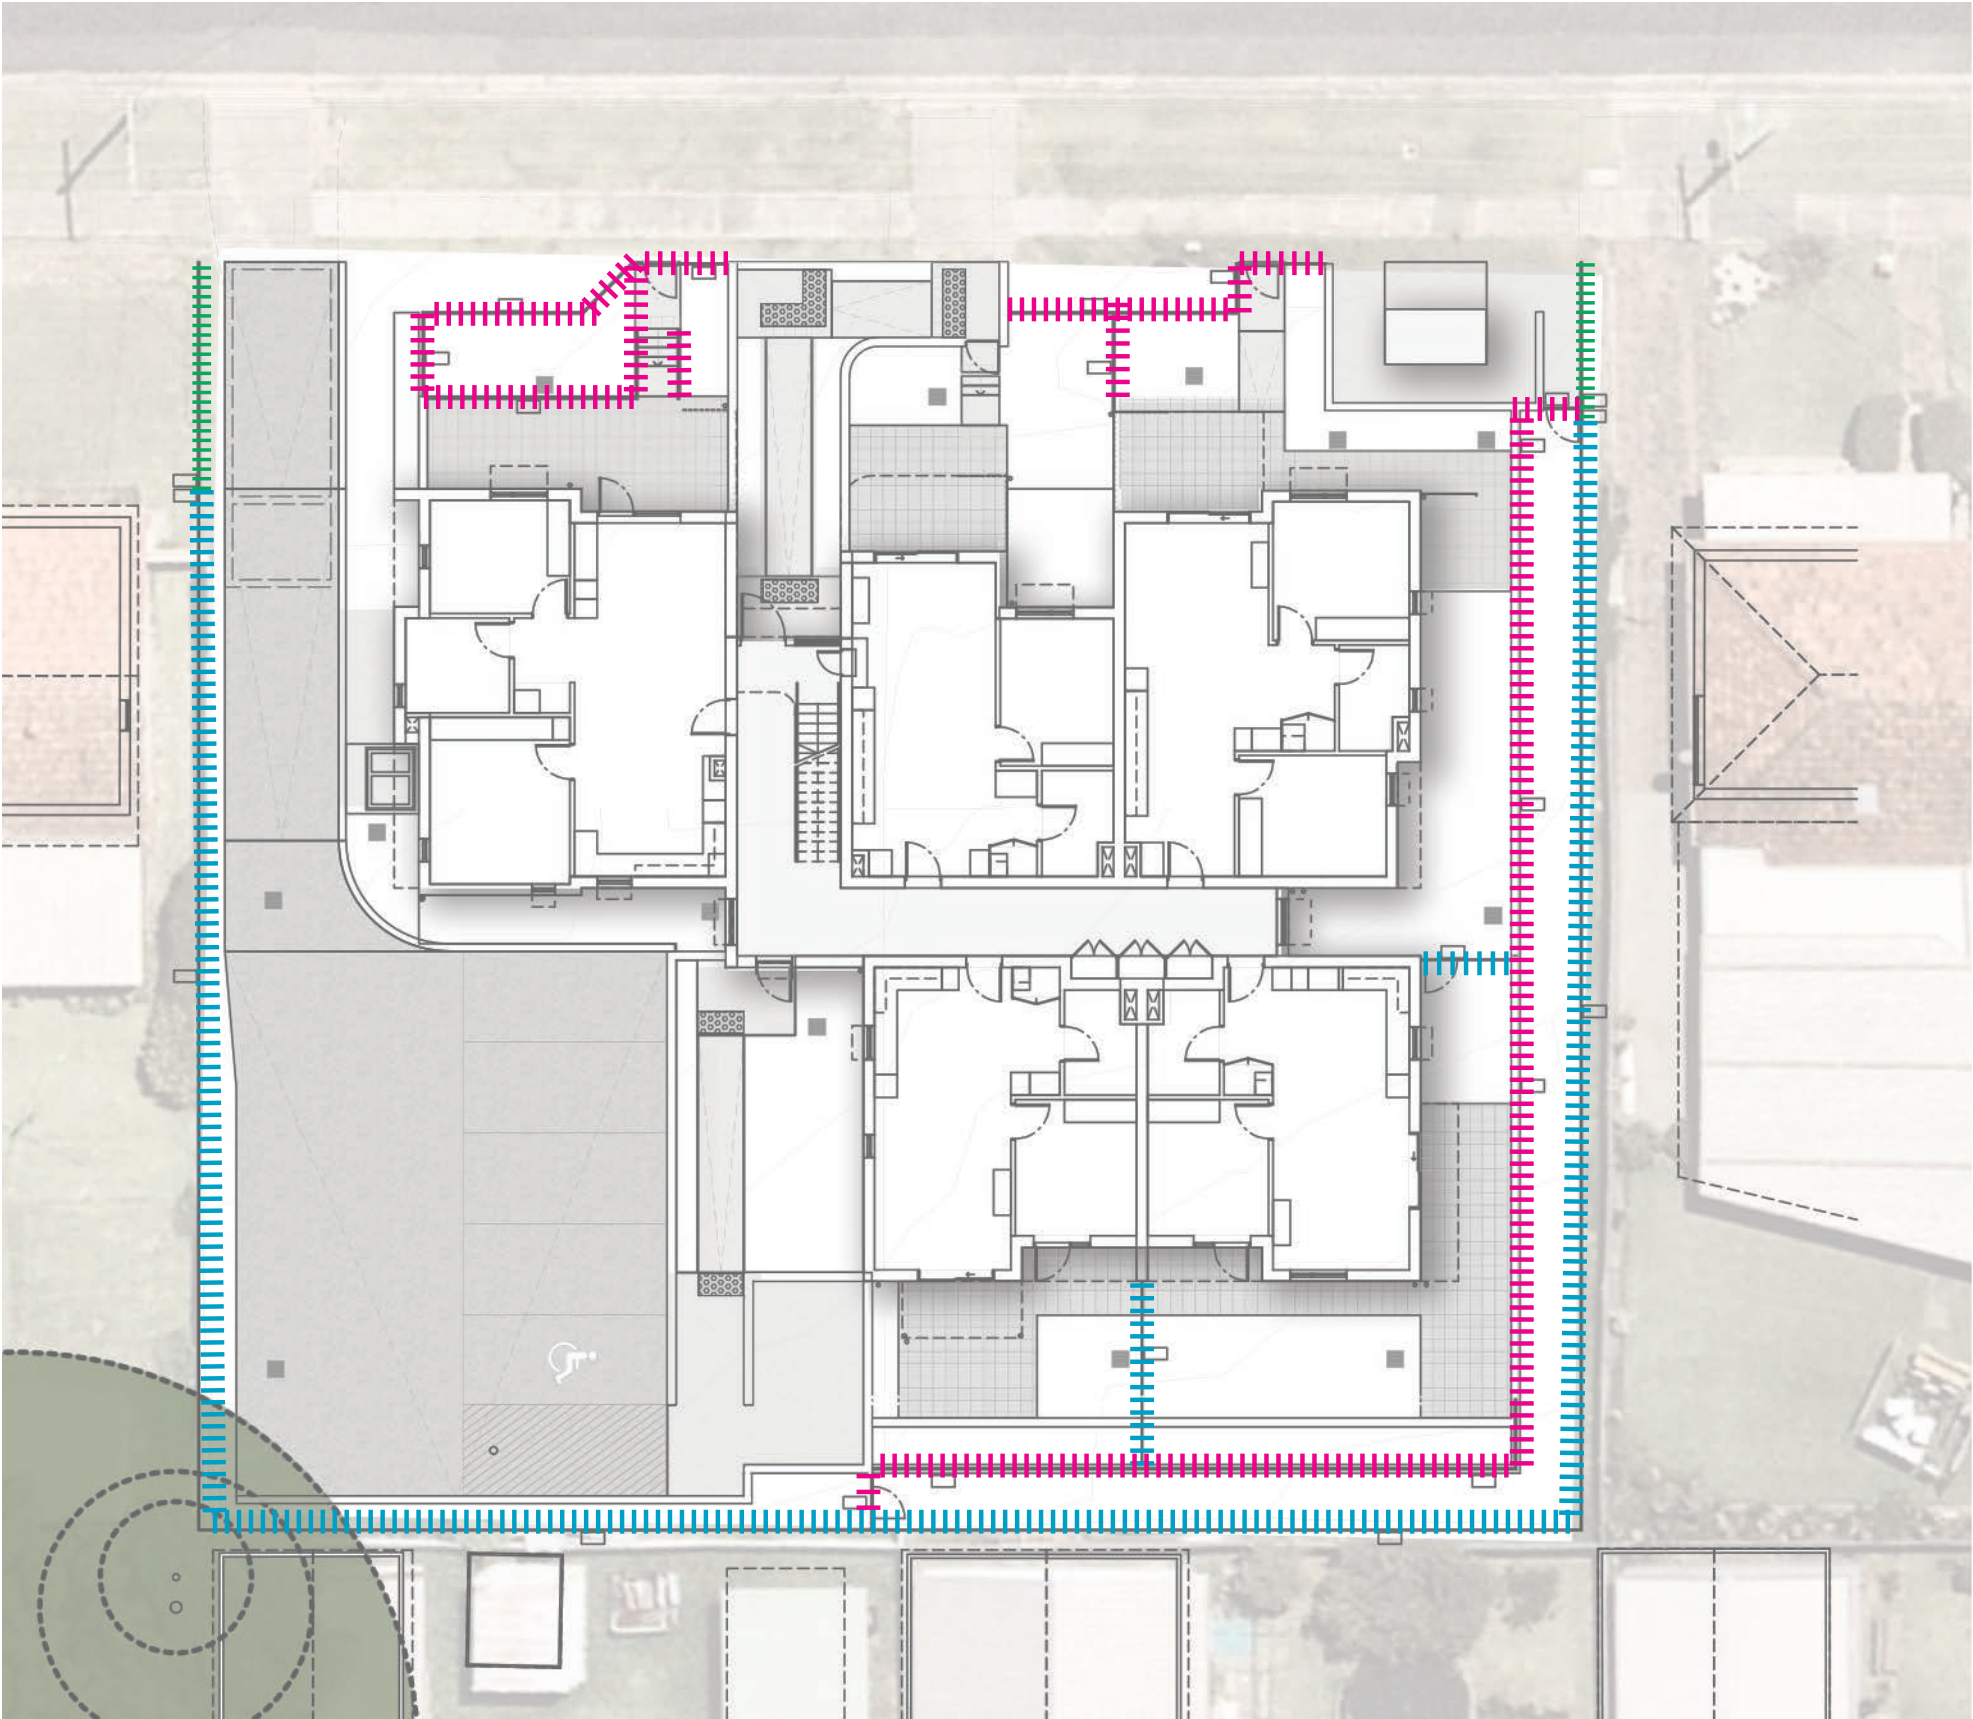

LEGEND:


- Fence Type 1: Colorbond fence (1800mm)
- Fence Type 2: Aluminium palisade fence/gate (1200mm)
- Fence Type 3: Aluminium palisade fence (800mm)




LANDSCAPE KEY PLAN AND SECTIONS

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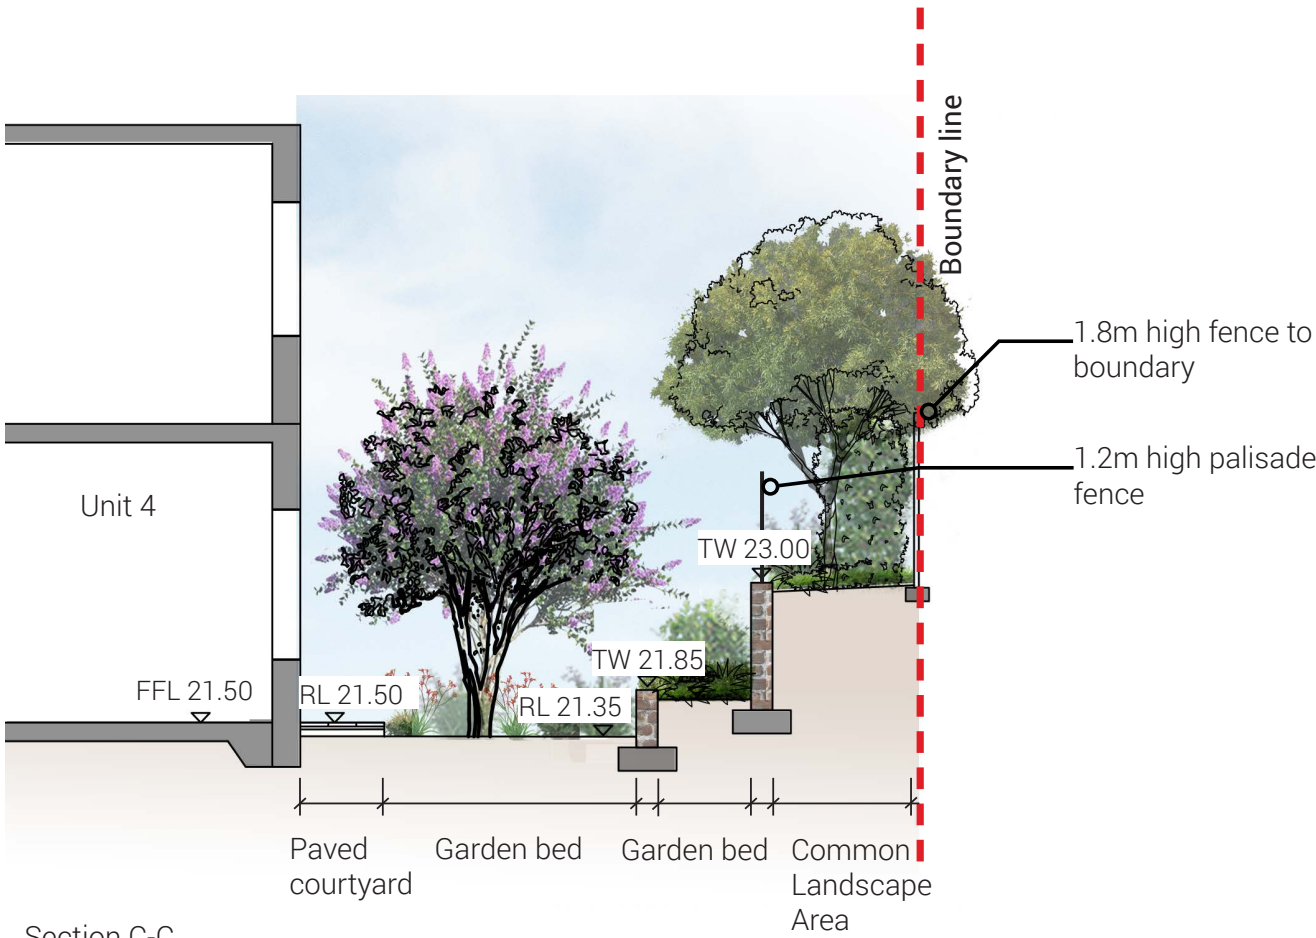
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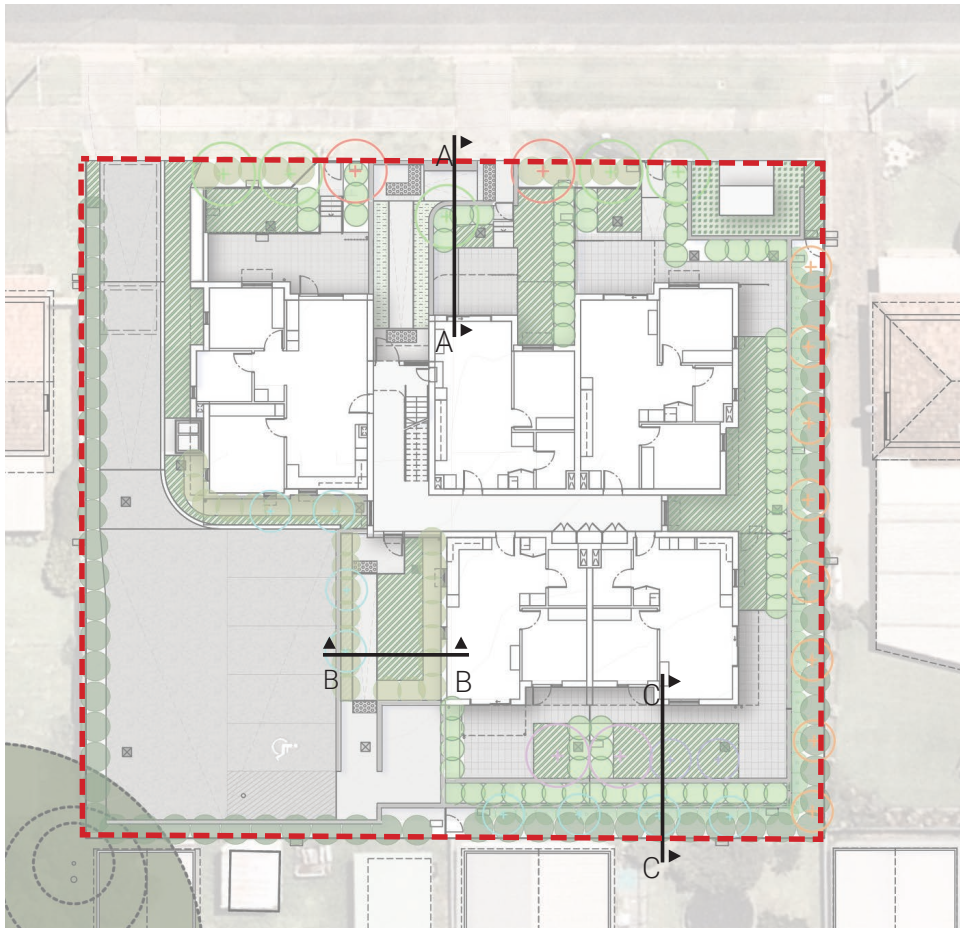
Section A-A

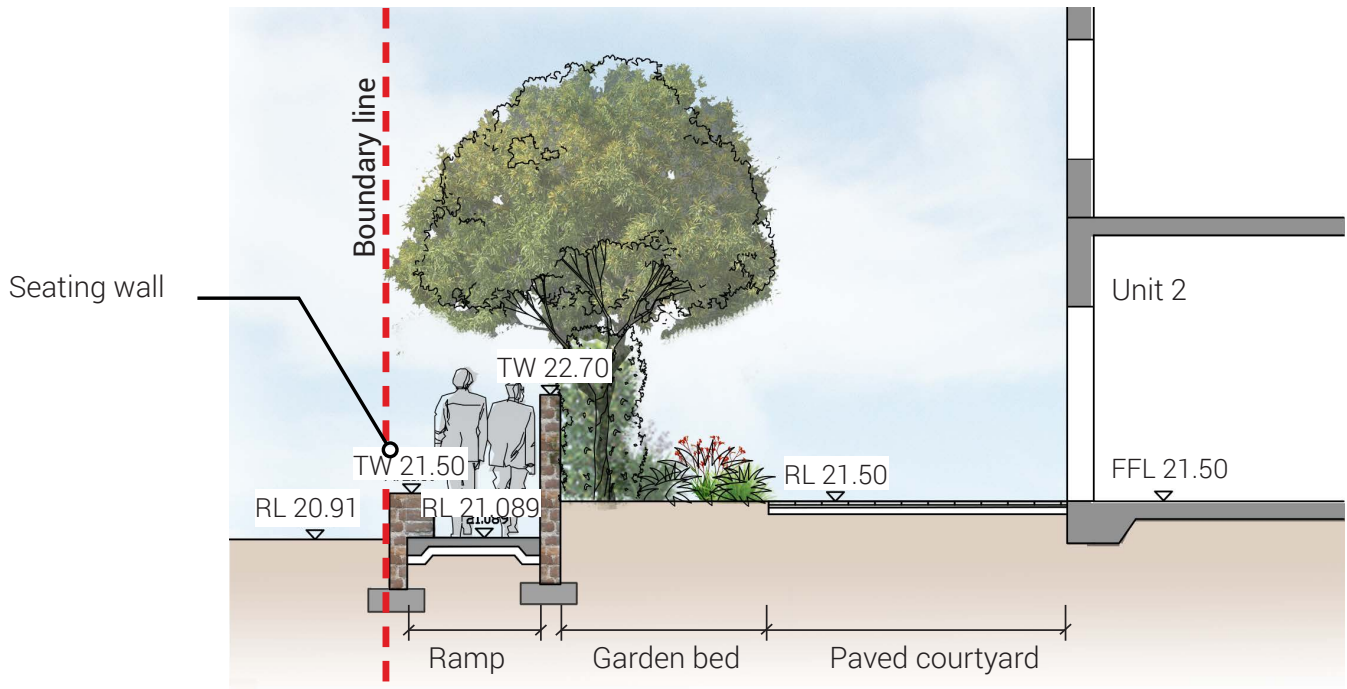

Section B-B

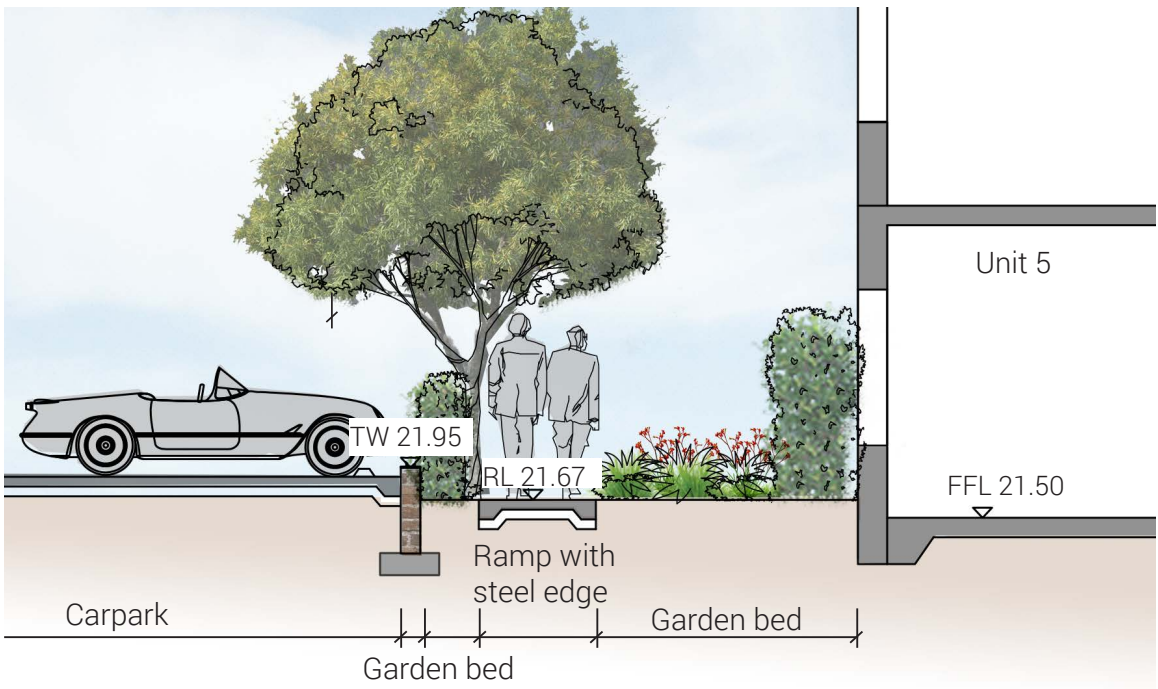

Section C-C



Key Plan



PLANTING SCHEDULE

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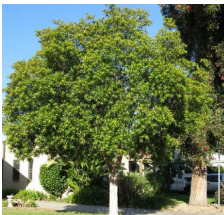
*Handwritten signature*

LAHC_WALLSEND, CURRY STREET PLANTING SCHEDULE						
SYM	Botanical Name	Common Name	Mature Height	Pot Size	Spacing /m2	Quantity
TREES						
Ee	Elaeocarpus eumundi	Eumundi Quandong	10m	100L	As shown	8
Er	Elaeocarpus reticulatis 'Green Dream'	Blueberry Ash	3m	100L	As shown	8
Li	Lagerstroemia indica x fauriei 'Tuscarora'	Crepe Myrtle	6m	100L	As shown	2
Mi	Malus ioensis 'Plena'	Flowering Crab Apple	5m	100L	As shown	2
Ms	Melaleuca styphelioides	Prickly Paperbark	15m	100L	As shown	2
Tl	Tristaniopsis laurina 'Luscious'	Water Gum	12m	100L	As shown	5
SHRUBS						
Cv	Callistemon viminalis 'Captain Cook'	Weeping Bottlebrush	1.8m	150mm	As shown	35
Cwa	Callistemon 'White Anzac'	Bottlebrush 'White Anzac'	1m	150mm	As shown	44
Mct	Melaleuca 'Claret Tops'	Honey Myrtle	1m	150mm	As shown	69
Mp	Myoporum parvifolium	Boobialla	0.2m	150mm	1.5/linm	165
Sa	Syzygium australe	Brush Cherry	2m	200mm	As shown	62
Mix 1						
Clj	Callistemon 'Little John'	Bottlebrush 'Little John'	0.8m	150mm	6	11
Gt	Gazania tomentosa	Silver Leaf Gazania	0.2m	150mm	8	7
Lm	Liriope muscari 'Just Right'	Lilyturf	0.5m	150mm	6	11
Ll	Lomandra longifolia 'Tankia'	Mat Rush	0.6m	150mm	6	11
Od	Ozothamnus diosmifolius 'Coral Flush'	Rice Flower	1m	150mm	6	8
Pbb	Phormium 'Bronze Baby'	Dwarf New Zealand Flax	0.6m	150mm	6	8
Mix 2						
Dc	Dianella caerulea	Blue Flax-lily	1m	150mm	4	139
De	Doryanthes excelsa	Gynea Lily	2m	200mm	2	37
Lm	Liriope muscari 'Just Right'	Just Right	0.5m	150mm	6	208
Mp	Myoporum parvifolium	Boobialla	0.2m	150mm	8	149
Pp	Pandorea pandorana 'Flat White'	Wonga Wonga Vine	0.3m	150mm	8	149

TREES



Elaeocarpus eumundi



Tristaniopsis laurina 'Luscious'



Lagerstroemia indica x fauriei 'Tuscarora'



Elaeocarpus reticulatus 'Green Dream'



Malus ioensis 'Plena'



Melaleuca styphelioides

Shrubs - Hedging & Screening



Syzygium australe



Melaleuca 'Claret Tops'



Callistemon 'White Anzac'



Callistemon viminalis



Myoporum parvifolium

MIX 1 - Planting to entry



Liriope muscari 'Just Right'



Lomandra 'Tanika'



Ozothamnus diosmifolius 'Coral Flush'



Gazania tomentosa



Phormium 'Bronze Baby'



Callistemon 'Little John'

MIX 2 - Medium and low planting



Liriope muscari 'Just Right'



Pandorea pandorana 'Flat White'



Dianella caerulea



Doryanthes excelsa






Myoporum parvifolium




MATERIAL SELECTION


DETERMINED by the NSW Land and Housing Corporation on:  
8 March 2023

*[Signature]*

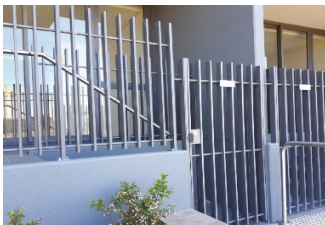
LAHC_CURRY STREET SELECTION SCHEDULE			
DESCRIPTION	DIMENSIONS	SPECIFICATION	IMAGE
FIXTURES AND FURNITURE			
FENCE TYPE 1	H: 1800mm	<b>Description:</b> Trimclad Colorbond steel fence <b>Panel dimension:</b> 2365mm L X 1800mm H <b>Color:</b> Monument grey <b>Fixing:</b> Refer to manufacture recommendation	
FENCE TYPE 2	H: 1200mm	<b>Description:</b> Vertica steel slate fence panel <b>Dimension:</b> 1200mm high <b>Fixing:</b> Refer to manufacture recommendation <b>Colour:</b> TBC+A9:E12	
FENCE TYPE 3	H: 800mm	<b>Description:</b> Vertica steel slate fence panel <b>Dimension:</b> 1800mm high <b>Fixing:</b> Refer to manufacture recommendation <b>Colour:</b> TBC	

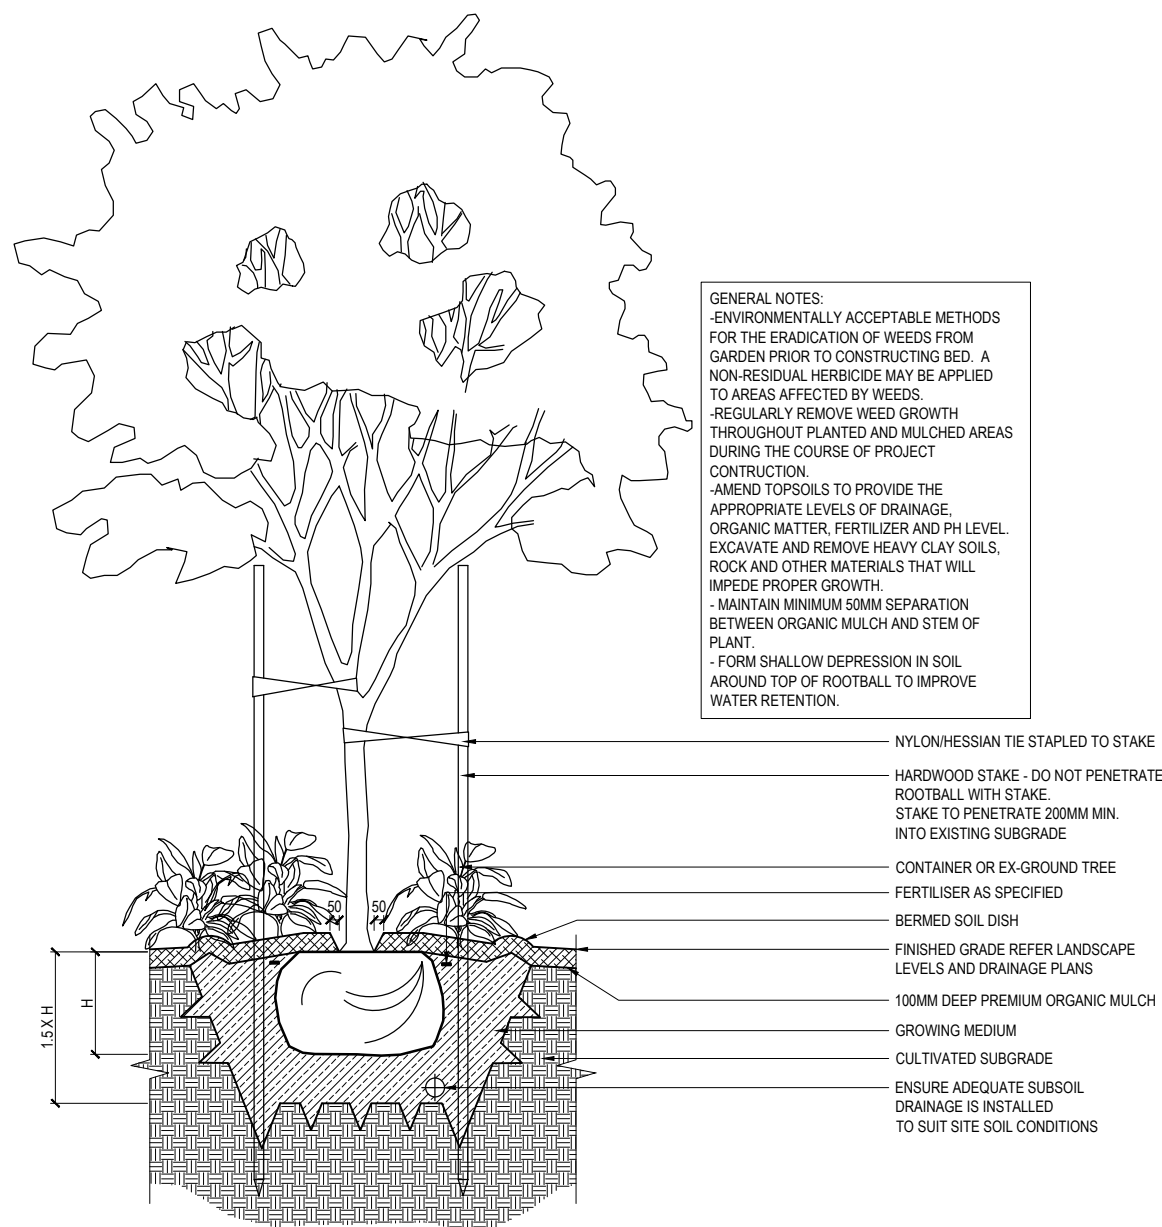


Detail 1: Tree Planting 1:40 @A3

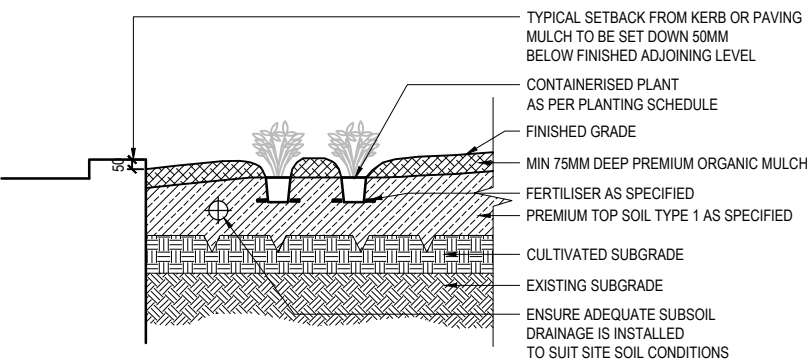


Detail 3: Mass Planting Detail 1:40 @A3

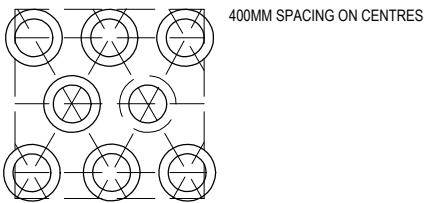

Mass Planting Layout Detail 1:40@A3

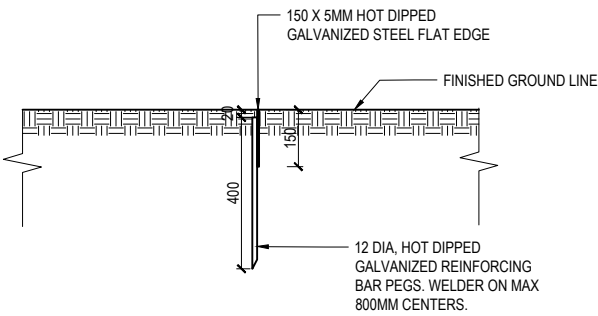

Detail 2: Steel Edge Detail 1:20 @A3

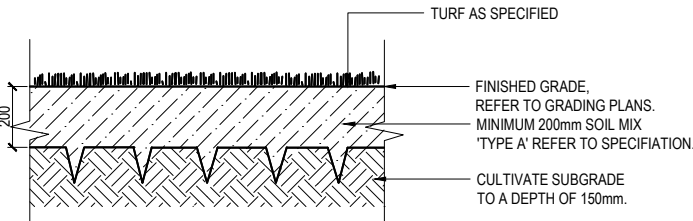

Detail 4: Typical Turf Detail 1:20 @A3



DATE PLOTTED: 28 November 2022 1:59 PM BY: ROCCO LARA



Cardno (NSW/ACT) Pty Ltd | ABN 95 001 145 035  
Level 9, The Forum, 203 Pacific Highway  
St. Leonards, NSW 2065  
Tel: 02 9496 7700 Fax: 02 9439 5170  
Web: www.cardno.com.au

DETERMINED by the NSW Land and Housing Corporation on:  
8 March 2023

*Edith*

LAHC & SAMCRAWFORD ARCHITECTS

PROPOSED DEVELOPMENT AT  
47-49 CURRY STREET  
WALLSEND 2287

COVER SHEET,  
LOCALITY PLAN AND  
SCHEDULE OF DRAWINGS

SCHEDULE OF DRAWINGS	
DRAWING No.	DESCRIPTION
DISCIPLINE	
80822047-CI-0001	COVER SHEET, LOCALITY PLAN AND SCHEDULE OF DRAWINGS
80822047-CI-0002	CIVIL CONSTRUCTION NOTES
80822047-CI-1101	STORMWATER DRAINAGE PLAN GROUND FLOOR
80822047-CI-1102	CUT AND FILL PLAN
80822047-CI-1103	BULK EARTHWORK LEVEL
80822047-CI-1201	SEDIMENTATION AND EROSION CONTROL
80822047-CI-2101	STORMWATER DETAILS SHEET 1
80822047-CI-2102	STORMWATER DETAILS SHEET 2
80822047-CI-2103	STORMWATER DETAILS SHEET 3 OSD RAINWATER TANK DETAILS
80822047-CI-2201	SEDIMENTATION AND EROSION CONTROL DETAILS

INDICATIVE SITE COMPOUND



INDICATIVE AREA  
OF WORKS

LOCALITY PLAN  
N.T.S

XREFs: CAD File: \\cardno-cop\global\AU\NSW\Drawings\Structure\Projects\80822047-47-49 Curry Street Wallsend\012\_CIVIL\Drawings\Build\80822047-CI-0001.dwg

5	28/11/2022	REVISED ISSUE FOR DA APPROVAL	A.L	P.L	M.R
4	1/06/2022	REVISED ISSUE	K.P.	C.F.	
3	4/04/2022	REVISED ISSUE FOR DA APPROVAL	K.P.	C.F.	
2	7/03/2022	ISSUE FOR DA APPROVAL	K.P.	C.F.	
1	10/02/2021	PRELIMINARY ISSUE	G.M.	K.P.	C.F.
Rev.	Date	Description	Des.	Verif.	Appd.

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ACN 165 409 567 Nominated Architect Sam Crawford 6498

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Drawn G.M.	Date FEB' 2022	Status	<b>FOR APPROVAL</b> NOT TO BE USED FOR CONSTRUCTION PURPOSES		
Checked K.P.	Date FEB' 2022				
Designed G.M.	Date FEB' 2022				
Verified C.F.	Date FEB' 2022				
Approved					
Drawing Number			Revision		
80822047-CI-0001			5		



GENERAL CIVIL NOTES

- THESE DRAWINGS SHALL BE READ IN CONJUNCTION WITH ALL OTHER CONSULTANTS DRAWINGS, SPECIFICATIONS, STANDARDS, LOCAL GOVERNMENT ORDINANCES AND ADDITIONAL WRITTEN INSTRUCTIONS THAT MAY BE ISSUED DURING THE COURSE OF THE CONTRACT.
- THE INFORMATION CONTAINED ON THESE DRAWINGS IS FOR CIVIL ENGINEERING PURPOSES ONLY.
- ALL DISCREPANCIES THAT COULD RESULT IN CHANGES TO THE CIVIL DETAILS SHALL BE REFERRED TO THE CIVIL ENGINEER PRIOR TO PROCEEDING WITH CONSTRUCTION.  
IF IN DOUBT ASK
- THE CONTRACTOR SHALL CHECK AND BE RESPONSIBLE FOR THE CORRECTNESS OF ALL DIMENSIONS AND ANY DISCREPANCY SHALL BE REPORTED IMMEDIATELY TO THE SUPERINTENDENT. DIMENSIONS SHALL NOT BE OBTAINED (INCLUSIVE OF ELECTRONIC COPIES) BY SCALING FROM THE DRAWINGS.
- ALL LEVELS ARE IN METRES AND ALL DIMENSIONS ARE IN MILLIMETRES U.N.O.
- IT IS THE CONTRACTOR'S SOLE RESPONSIBILITY TO ENSURE THE SAFETY AND STABILITY OF NEW AND EXISTING STRUCTURES, TEMPORARY STRUCTURES, EXCAVATIONS, SHORING AND THE LIKE DURING CONSTRUCTION.
- THE CONTRACTOR SHALL NOTIFY THE ENGINEER FORTY EIGHT (48) HOURS BEFORE ANY SITE INSPECTION IS REQUIRED.
- ALL MATERIALS AND WORKMANSHIP SHALL BE IN ACCORDANCE WITH THE RELEVANT AND CURRENT AUSTRALIAN STANDARDS AND WITH THE BY-LAWS AND ORDINANCES OF THE RELEVANT BUILDING AUTHORITIES EXCEPT WHERE VARIED BY THE PROJECT SPECIFICATION.
- ALL WORK IS TO BE CARRIED OUT IN ACCORDANCE WITH ALL WORKCOVER REQUIREMENTS AND OCCUPATIONAL HEALTH AND SAFETY ACT REGULATIONS.
- ALL PROPRIETARY PRODUCTS AND APPROVED EQUIVALENTS NOTED ON THE DRAWINGS SHALL BE SUPPLIED AND INSTALLED IN STRICT ACCORDANCE WITH THE MANUFACTURER'S SPECIFICATIONS.
- SUBSTITUTIONS OF NOMINATED PRODUCTS AND MATERIALS SHALL ONLY OCCUR IF APPROVED BY CARDNO. NO SUBSTITUTIONS SHALL BE MADE OR SIZES OF STRUCTURAL MEMBERS VARIED WITHOUT OBTAINING THE APPROVAL OF THE ENGINEER. THE APPROVAL OF A SUBSTITUTION FROM THE ENGINEER SHALL NOT BE AN AUTHORISATION FOR AN EXTRA EXPENSE CLAIM. ANY EXTRA COST INVOLVED SHALL BE TAKEN UP WITH THE SUPERINTENDENT BEFORE THE WORK COMMENCES.
- NO CHANGES SHALL BE MADE WITHOUT THE WRITTEN CONSENT OF THE ENGINEER.
- CONSTRUCTION FROM THESE DRAWINGS AND ASSOCIATED CONSULTANTS' DRAWINGS SHALL NOT COMMENCE UNTIL APPROVED BY THE LOCAL AUTHORITIES AND PRINCIPAL CERTIFYING AUTHORITY.
- CONTRACTOR IS NOT TO ENTER UPON NOR DO ANY WORK WITHIN ADJACENT LANDS OR PROPERTIES WITHOUT THE PERMISSION OF THE OWNERS AND SUPERINTENDENT.
- THE CONTRACTOR SHALL PROVIDE TRAFFIC CONTROL WHICH COMPLIES WITH AS1742.3 - 2018. A COPY OF THE PLAN SHOWING LAYOUT OF PROPOSED TRAFFIC CONTROL FOR THE COMMENCEMENT OF WORK AND CERTIFIED BY A SUITABLY QUALIFIED PERSON IS TO BE SUBMITTED TO COUNCIL PRIOR TO COMMENCEMENT OF ANY WORK. FURTHER PLANS ARE TO BE SUBMITTED IF WORK SITE ALTERS.
- ANY QUANTITIES GIVEN ARE FOR GUIDANCE ONLY.

SITE PREPARATION

ROAD WORKS

- REMOVE TOP SOIL, ROOT AFFECTED SOIL, FILL AND OTHER DELETERIOUS MATERIAL TO EXPOSE NATURAL SUBGRADE.
- THE EXPOSED SUBGRADE SHOULD THEN BE PROOF ROLLED WITH AT LEAST EIGHT (8) PASSES OF A 10 TONNE MIN. DEAD WEIGHT ROLLER. ANY SOFT OR HEAVING AREAS SHOULD BE REMOVED TO A MAXIMUM DEPTH OF 300mm AND REPLACED WITH CLEAN WELL GRADED MATERIAL SUCH AS RIPPED OR CRUSHED SANDSTONE COMPACTED TO AT LEAST 100% OF STANDARD MAXIMUM DRY DENSITY (SMDD) AT ±2% OPTIMUM MOISTURE CONTENT IN ACCORDANCE WITH AS1289.
- COMPACTED FILL SHOULD BE PLACED IN LAYERS NOT EXCEEDING 150mm THICK AND COMPACTED TO AT LEAST 100% SMDD. FILL SHALL CONSIST OF CLEAN WELL GRADED MATERIAL SUCH AS RIPPED OR CRUSHED SANDSTONE WITH A MIN. CBR OF 15%.
- DENSITY TESTING SHALL BE CARRIED OUT TO LEVEL 2 CERTIFICATION IN ACCORDANCE WITH AS3798.
- SUB-BASE COURSE - TO BE DGS20 OR DGS40 OR RIPPED OR CRUSHED SANDSTONE WITH A CBR GREATER THAN 40%, MAXIMUM PARTICLE SIZE OF 60mm, WELL GRADED WITH A PLASTIC INDEX LESS THAN 10. COMPACT TO AN AVERAGE OF NOT LESS THAN 100% SMDD WITH A MINIMUM VALUE OF 98% SMDD.
- ALL KERBS TO BE FORMED BY KERB MACHINE AND NOT BY HAND.
- EXTERNAL FOOTPATHS/PAVEMENTS
- REMOVE TOP SOIL, ROOT AFFECTED SOIL, FILL AND OTHER DELETERIOUS MATERIAL TO EXPOSE NATURAL SUBGRADE.
- THE EXPOSED SUBGRADE SHOULD BE PROOF ROLLED. ANY SOFT OR HEAVING AREAS SHOULD BE REPLACED WITH CLEAN WELL GRADED MATERIAL. FILL IF REQUIRED, SHOULD BE CLEAN AND WELL GRADED. COMPACT TO 100% SMDD.

STORMWATER DRAINAGE NOTES

- STORMWATER DRAINAGE SHALL BE INSTALLED IN ACCORDANCE WITH AS3500.3-2018.
- PIPES Ø675mm AND LARGER SHALL BE CLASS 3 APPROVED SPIGOT AND SOCKET REINFORCED CONCRETE PIPES WITH RUBBER RING JOINTS U.N.O. IN ACCORDANCE WITH ASINZS3725-2007.
- PIPES Ø375mm TO Ø600mm SHALL BE CLASS 2 APPROVED SPIGOT AND SOCKET REINFORCED CONCRETE PIPES WITH RUBBER RING JOINTS U.N.O. IN ACCORDANCE WITH ASINZS3725-2007.
- PIPES UP TO AND INCLUDING Ø300mm SHALL BE uPVC DWV (GRADE CLASS SN8) U.N.O. IN ACCORDANCE WITH ASINZS1260-2017. ENLARGERS, CONNECTIONS, TAPERS, JUNCTIONS ETC TO BE PREFABRICATED PURPOSE MADE FITTINGS WITH SOLVENT WELDED JOINTS.
- SUBSOIL PIPES AND FITTINGS TO BE PERFORATED PLASTIC IN ACCORDANCE WITH AS2439.1-2007. LAY PIPES ON FLOOR OF TRENCH WITH MINIMUM 1% GRADE AND OVERLAY WITH FILTER MATERIAL EXTENDING TO WITHIN 200mm OF SURFACE. PROVIDE FILTER FABRIC OF PERMEABLE POLYPROPYLENE BETWEEN FILTER MATERIAL AND TOPSOIL.
- HEAVY DUTY uPVC PIPES TO BE IN ACCORDANCE WITH ASINZS1254-2010 MAY BE USED WITHIN ALLOTMENTS.
- EQUIVALENT STRENGTH FIBROUS REINFORCED CONCRETE (F.R.C.) AND/OR HIGH DENSITY POLYETHYLENE (H.D.P.E.) MAY BE USED SUBJECT TO APPROVAL BY THE SUPERINTENDENT.
- CONTRACTOR TO SUPPLY AND INSTALL ALL FITTINGS AND SPECIALS INCLUDING VARIOUS PIPE ADAPTORS TO ENSURE PROPER CONNECTION BETWEEN DISSIMILAR PIPEWORK.
- ALL CONNECTIONS TO EXISTING DRAINAGE PITS SHALL BE MADE IN A TRADESMAN-LIKE MANNER AND THE INTERNAL WALL OF THE PIT AT THE POINT OF ENTRY SHALL BE CEMENT RENDERED TO ENSURE A SMOOTH FINISH WITH NO PROTRUSIONS.
- BEDDING MATERIAL SHALL BE TYPE H2 U.N.O. FOR PIPES NOT UNDER PAVEMENTS, AND TYPE HS2 FOR PIPES UNDER PAVEMENTS IN ACCORDANCE WITH ASINZS3725-2007.
- ALL PIPES ARE TO BE UNIFORMLY SUPPORTED ALONG THE LENGTH OF THE BARREL BY SUITABLE FILL MATERIAL. PIPES WITH SOCKETS SHALL BE LAID WITH RECESSES IN BEDDING MATERIAL TO ENSURE PIPES DO NOT BEAR ON THEIR SOCKETS.
- MINIMUM GRADE TO STORMWATER LINES TO BE 1% U.N.O.
- ANY PIPES OVER 16% GRADE SHALL HAVE CONCRETE BULKHEADS AT ALL JOINTS.
- CARE IS TO BE TAKEN WITH LEVELS OF STORMWATER LINES. GRADES SHOWN ARE NOT TO BE REDUCED WITHOUT APPROVAL.
- PROVIDE 3m LENGTH OF Ø100mm SUBSOIL DRAINAGE LINE OR 200mm 'NYLEX' STRIP DRAIN SURROUNDED WITH 150mm OF 20mm BLUE METAL OR GRAVEL, AND WRAPPED IN 'BIDUM' A24 GEOTEXTILE FILTER FABRIC OR APPROVED EQUIVALENT, AT INVERT OF EACH INCOMING UPSTREAM PIPE TRENCH ON EACH PIT.
- ALL STORMWATER DRAINAGE LINES UNDER PROPOSED BUILDING SLABS TO BE uPVC PRESSURE PIPE GRADE 6. ENSURE ALL VERTICALS AND DOWNPIPES ARE uPVC PRESSURE PIPE, GRADE 6 FOR A MIN OF 3.0m IN HEIGHT.
- WHERE SUBSOIL DRAINAGE LINES PASS UNDER FLOOR SLABS AND VEHICULAR PAVEMENTS, UNSLOTTED uPVC DWV (GRADE CLASS SN8) PIPE SHALL BE USED.
- UNLESS NOTED OTHERWISE ON THE PLANS, PROVIDE THE FOLLOWING MINIMUM COVER TO ALL STORMWATER PIPES:  
UNDER LANDSCAPE & PAVEMENT - 300mm  
UNDER ROAD (TRAFFIC) - 600mm
- REFER TO ASINZS3725-2007 TABLE B1 FOR REQUIRED FILL DEPTHS ABOVE PIPE BARREL PRIOR TO USE OF COMPACTION MACHINERY OR TRAVERSING OF PIPES BY GENERAL SITE EQUIPMENT. THE CONTRACTOR IS TO ENSURE COMPACTION EQUIPMENT IS APPROPRIATE FOR THE PIPE CLASS USED. WHERE WORKING METHODS REQUIRE HIGHER CLASS PIPE, THE CONTRACTOR SHALL REFER TO AS3725-2007 TO DETERMINE THE APPROPRIATE PIPE CLASS. PROPOSED CHANGES TO PIPE CLASS SHALL BE REVIEWED BY CARDNO PRIOR TO INSTALLATION.
- BACKFILL PIPE TRENCHES WITH SANDY LOAM OR APPROVED GRANULAR BACKFILL TO MINIMUM COVER ABOVE THE PIPE. WHERE THE PIPE IS UNDER PAVEMENTS BACKFILL REMAINDER OF TRENCH TO PAVEMENT SUBGRADE WITH SAND OR APPROVED GRAVEL SUB-BASE COMPACTED IN 150mm LAYERS TO 98% STANDARD MAXIMUM DRY DENSITY IN ACCORDANCE WITH AS1289 5.2.1. (OR A DENSITY INDEX OF NOT LESS THAN 75).
- FOR ALL IN-SITU CONCRETE ELEMENTS REFER TO CIVIL CONCRETE NOTES FOR CONCRETE STRENGTH AND COVER.
- PRECAST CONCRETE PITS MAY BE INSTALLED IN LIEU OF CAST IN-SITU PITS, WHEN PIPE JUNCTIONS ARE ACCOMMODATED WITHIN THE OVERALL DIMENSIONS OF THE PIT, AND APPROVED BY CARDNO.
- PITS DEEPER THAN 1200mm, MEASURED FROM TOP OF GRATE TO INVERT OF PIT, SHALL HAVE STEP IRONS INSTALLED IN ACCORDANCE WITH THE LOCAL OR STATUTORY AUTHORITY REQUIREMENTS.
- ACCESS COVERS AND GRATES TO BE INSTALLED IN ACCORDANCE WITH AS3996-2019.
- ALL GRATES IN PAVEMENTS TO BE CYCLE SAFE AND WHERE IN ROADWAYS TRAFFICABLE HEAVY DUTY.
- ALL BOX CULVERTS SHALL BE STRUCTURALLY DESIGNED BY THE MANUFACTURER AND DELIVERED TO SITE AS FIT FOR PURPOSE.
- AT ALL TIMES DURING CONSTRUCTION OF STORMWATER PITS, ADEQUATE SAFETY PROCEDURES SHALL BE TAKEN TO ENSURE AGAINST THE POSSIBILITY OF PERSONNEL FALLING DOWN PITS.
- ALL EXISTING STORMWATER DRAINAGE LINES AND PITS THAT ARE TO REMAIN ARE TO BE INSPECTED AND CLEANED. DURING THIS PROCESS ANY PART OF THE STORMWATER DRAINAGE SYSTEM THAT WARRANTS REPAIR SHALL BE REPORTED TO THE SUPERINTENDENT/ENGINEER FOR FURTHER DIRECTIONS.

EROSION AND SEDIMENT CONTROL NOTES

- ALL WORKS SHALL BE GENERALLY CARRIED OUT IN ACCORDANCE WITH:
  - LOCAL AUTHORITY REQUIREMENTS
  - EPA REQUIREMENTS
  - NSW DEPARTMENT OF HOUSING MANUAL "MANAGING URBAN STORMWATER, SOILS AND CONSTRUCTION", 4th EDITION, MARCH 2004 (THE BLUE BOOK).
- EROSION AND SEDIMENT CONTROL DRAWINGS AND NOTES ARE PROVIDED FOR THE WHOLE OF THE WORKS. SHOULD THE CONTRACTOR STAGE THESE WORKS THEN THE DESIGN MAY REQUIRE TO BE MODIFIED. VARIATIONS TO THESE DETAILS MAY REQUIRE TO BE APPROVED BY THE RELEVANT AUTHORITIES. THE EROSION AND SEDIMENT CONTROL PLAN SHALL BE IMPLEMENTED AND ADOPTED TO MEET THE VARYING SITUATIONS AS WORK ON SITE PROGRESSES.
- MINIMISE THE AREA OF SITE BEING DISTURBED AT ANY ONE TIME.
- THE CONTRACTOR SHALL BE SOLELY RESPONSIBLE FOR THE CONTROL OF EROSION AND SEDIMENTATION AND THAT ALL SOIL AND WATER MANAGEMENT WORKS ARE LOCATED AS DOCUMENTED OR AS OTHERWISE DIRECTED BY THE SUPERINTENDENT.
- ALL SOIL AND WATER CONTROL MEASURES ARE TO BE PUT BACK IN PLACE AT THE END OF EACH WORKING DAY AND MODIFIED TO BEST SUIT SITE CONDITIONS.
- PREVENT SITE RUNOFF ENTERING NEWLY CONSTRUCTED STORMWATER PITS UNLESS SEDIMENT FENCES ARE ERECTED AROUND THEM.
- MAINTAIN ALL STORMWATER PIPES AND PITS CLEAR OF DEBRIS AND SEDIMENT. INSPECT STORMWATER SYSTEM AND CLEAN OUT AS REQUIRED PARTICULARLY FOLLOWING EACH STORM EVENTS.
- MAINTAIN ALL EROSION AND SEDIMENT CONTROL DEVICES, ENSURING THEY ARE IN GOOD WORKING ORDER AND OPERATE EFFECTIVELY. REPAIRS AND/OR MAINTENANCE SHALL BE UNDERTAKEN AS REQUIRED PARTICULARLY FOLLOWING EACH STORM EVENTS.
- WHERE PRACTICAL, THE SOIL EROSION HAZARDS ON THE SITE ARE TO BE KEPT AS LOW AS POSSIBLE AND WORKS SHOULD BE UNDERTAKEN IN THE FOLLOWING SEQUENCE TO MINIMISE THE RISKS:
  - INSTALL A SEDIMENT FENCE ALONG THE BOUNDARIES AS SHOWN ON PLAN. REFER DETAIL.
  - CONSTRUCT STABILISED SITE ACCESS AND TRUCK WASH DOWN AREA AT THE LOCATION SHOWN ON THE DRAWINGS OR AS DETERMINED BY SUPERINTENDENT/ENGINEER. REFER DETAIL.
  - INSTALL ANY SEDIMENT BASINS AND SEDIMENT TRAPS AS SHOWN ON DRAWINGS. REFER DETAIL.
  - UNDERTAKE SITE DEVELOPMENT WORKS IN ACCORDANCE WITH THE ENGINEERING PLANS. WHERE POSSIBLE, PHASE DEVELOPMENT SO THAT LAND DISTURBANCE IS CONFINED TO AREAS OF WORKABLE SIZE.
- DURING WINDY WEATHER, LARGE, UNPROTECTED AREAS WILL BE KEPT MOIST (NOT WET) BY SPRINKLING WITH WATER TO KEEP DUST UNDER CONTROL.
- CONTROL WATER FROM UPSTREAM OF THE SITE SUCH THAT IT DOES NOT ENTER THE DISTURBED SITE.
- ALL CONSTRUCTION VEHICLES SHALL ENTER THE SITE VIA THE TEMPORARY CONSTRUCTION ENTRY/EXIT.
- ALL VEHICLES LEAVING THE SITE SHALL BE CLEANED AND INSPECTED BEFORE LEAVING.
- STOCKPILES ARE NOT TO BE LOCATED IN ROADWAYS, WITHIN 2 METRES OF HAZARD AREAS OR DRAINAGE PITS, INCLUDING LIKELY AREAS OF CONCENTRATED OR HIGH VELOCITY FLOWS SUCH AS WATERWAYS, WHERE THEY ARE BETWEEN 2 AND 5 METRES FROM SUCH AREAS. SPECIAL SEDIMENT CONTROL MEASURES SHOULD BE TAKEN TO MINIMISE POSSIBLE SCOUR AND EROSION TO DOWNSLOPE WATERS, E.G. THROUGH INSTALLATION OF SEDIMENT FENCING.
- ANY SAND USED IN THE CONCRETE CURING PROCESS (SPREAD OVER THE SURFACE) WILL BE REMOVED AS SOON AS POSSIBLE AND WITHIN 10 WORKING DAYS FROM PLACEMENT.
- WATER WILL BE PREVENTED FROM ENTERING THE PERMANENT DRAINAGE SYSTEM UNLESS IT IS RELATIVELY SEDIMENT FREE, I.E. THE CATCHMENT AREA HAS BEEN PERMANENTLY LANDSCAPED AND/OR ANY LIKELY SEDIMENT HAS BEEN FILTERED THROUGH AN APPROVED STRUCTURE OR DEVICE.
- TEMPORARY SOIL AND WATER MANAGEMENT STRUCTURES WILL BE REMOVED ONLY AFTER THE LANDS THEY ARE PROTECTING ARE REHABILITATED.
- ACCEPTABLE RECEPTACLES WILL BE PROVIDED FOR CONCRETE AND MORTAR SLURRIES, PAINTS, ACID WASHINGS, LIGHTWEIGHT WASTE MATERIALS AND LITTER.
- ANY EXISTING TREES WHICH FORM PART OF THE FINAL LANDSCAPING PLAN WILL BE PROTECTED FROM CONSTRUCTION ACTIVITIES BY:
  - PROTECTING THEM WITH BARRIER FENCING OR SIMILAR MATERIALS INSTALLED OUTSIDE THE DRIP LINE
  - ENSURING THAT NOTHING IS NAILED TO THEM
  - PROHIBITING PAVING, GRADING, SEDIMENT WASH OR PLACING OF STOCKPILES WITHIN THE DRIP LINE EXCEPT UNDER THE FOLLOWING CONDITIONS.
  - ENCROACHMENT ONLY OCCURS ON ONE SIDE AND NO CLOSER TO THE TRUNK THAN EITHER 1.5 METRES OR HALF THE DISTANCE BETWEEN THE OUTER EDGE OF THE DRIP LINE AND THE TRUNK, WHICH EVER IS THE GREATER
  - A DRAINAGE SYSTEM THAT ALLOWS AIR AND WATER TO CIRCULATE THROUGH THE ROOT ZONE (E.G. A GRAVEL BED) IS PLACED UNDER ALL FILL LAYERS OF MORE THAN 300mm DEPTH
  - CARE IS TAKEN NOT TO CUT ROOTS UNNECESSARILY NOR TO COMPACT THE SOIL AROUND THEM.
- FINAL SITE LANDSCAPING WILL BE UNDERTAKEN AS SOON AS POSSIBLE AND WITHIN 20 WORKING DAYS FROM COMPLETION OF CONSTRUCTION ACTIVITIES.
- ANY REVEGETATED AREAS WHICH FAIL TO ESTABLISH WITHIN THREE MONTHS MUST BE RE-SOWN.

CONCRETE NOTES

- ALL WORKMANSHIP AND MATERIALS SHALL BE IN ACCORDANCE WITH AS3600 AND AS1379 CURRENT EDITIONS WITH AMENDMENTS, EXCEPT WHERE VARIED BY THE CONTRACT DOCUMENTS.
- FOR CONCRETE MIX DESIGN & COVER SUMMARY REFER TO TABLE C1.1 BELOW. ALL CEMENT TO BE TYPE 'GP' GENERAL PURPOSE CEMENT IN ACCORDANCE WITH AS3972-2010, EXCEPT THAT THE MAXIMUM SHRINKAGE OF THE CEMENT IN THE MORTAR TEST SAMPLE IN ACCORDANCE WITH AS2350 SHALL BE LESS THAN 600 MICROSTRAIN.
- PROJECT ASSESSMENT SHALL BE CARRIED OUT IN ACCORDANCE WITH AS 1379-2007 CLAUSE B7:
  - ALL CONCRETE IN SLABS AND BEAMS TO BE PROPORTIONED TO LIMIT DRYING SHRINKAGE TO 650 MICROSTRAIN AT 56 DAYS.
  - DETAILS OF THE PROPOSED MIX TO BE SUBMITTED AND APPROVAL OBTAINED PRIOR TO POURING ANY CONCRETE.
- NO ADMIXTURES OTHER THAN THOSE SPECIFIED IN THE CONCRETE QUALITY & COVER SUMMARY TABLE C1.1 (OR APPROVED EQUIVALENTS) SHALL BE USED IN CONCRETE UNLESS APPROVED BY THE ENGINEER, WITH THE ONLY EXCEPTION BEING LOW RANGE WATER REDUCING ADMIXTURE.
- CLEAR CONCRETE COVER TO REINFORCEMENT SHALL BE IN ACCORDANCE WITH CONCRETE QUALITY & COVER TABLE C1.1.
- CONSTRUCTION JOINTS, WHERE NOT SHOWN, SHALL BE LOCATED TO THE APPROVAL OF THE STRUCTURAL ENGINEER.
- ALL CONCRETE SHALL BE MECHANICALLY VIBRATED TO ACHIEVE A DENSE HOMOGENEOUS MASS, COMPLETELY FILLING THE FORMWORK THOROUGHLY EMBEDDING THE REINFORCEMENT AND FREE OF STONE POCKETS. ALL CONCRETE INCLUDING SLABS ON GROUND AND FOOTINGS SHALL BE COMPACTED WITH MECHANICAL VIBRATORS.
- CURING OF ALL CONCRETE IS TO BE ACHIEVED BY KEEPING SURFACES CONTINUOUSLY WET FOR A PERIOD OF THREE (3) DAYS, AND THE PREVENTION OF LOSS OF MOISTURE FOR A TOTAL OF SEVEN (7) DAYS FOLLOWED BY A GRADUAL DRYING OUT. APPROVED SPRAY ON CURING COMPOUNDS THAT COMPLY WITH AS3799 MAY BE USED WHERE FLOOR FINISHES WILL NOT BE AFFECTED (REFER MANUFACTURERS SPECIFICATION). PVA BASED CURING COMPOUNDS ARE NOT ACCEPTABLE. POLYTHENE SHEETING OR WET HESSIAN MAY BE USED IF PROTECTED FROM WIND AND TRAFFIC.
- REPAIRS TO CONCRETE SHALL NOT BE ATTEMPTED WITHOUT THE PERMISSION OF THE ENGINEER.
- CAS-IN FIXINGS, BOLTS ETC. SHALL NOT BE ALTERED WITHOUT THE PERMISSION OF THE

CONCRETE MIX DESIGN & COVER - TABLE C1.1							
MIN. CEMENT CONTENT = 300 kg/m³							
MAX. PERMISSIBLE DRYING SHRINKAGE = 600 MICROSTRAIN AT 56 DAYS							
STRUCTURAL ELEMENT	SLUMP (MAX)	MAX. AGG. SIZE	CEMENT TYPE	STRENGTH GRADE	ADMIXTURE	REBAR COVER	
						TOP	BTM
STORMWATER PITS	80	Ø20mm	GP	32MPa	-	40	40
KERBING	80	Ø20mm	GP	32MPa	-	40	40
SLABS ON GROUND	80	Ø20mm	GP	32MPa	-	40	40
BORED PIERS	80	Ø20mm	GP	32MPa	-	50	
STRIP FOOTINGS	80	Ø20mm	GP	32MPa	-	50	
BLOCK WALL CORE GROUT FILLING (UNO)	230	Ø10mm	GP	25MPa	-	65	

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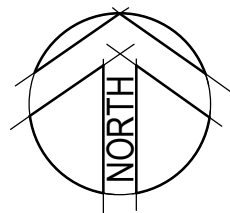


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Drawn K.P.	Date FEB' 2022	Client LAHC & SAMCRAWFORD ARCHITECTS
Checked K.P.	Date FEB' 2022	Project PROPOSED DEVELOPMENT AT
Designed K.P.	Date FEB' 2022	47-49 CURRY STREET
Verified C.F.	Date FEB' 2022	WALLSEND 2287
Approved		Title CIVIL CONSTRUCTION NOTES

Status <b>FOR APPROVAL</b>			
NOT TO BE USED FOR CONSTRUCTION PURPOSES			
Datum AHD	Scale N/A	Size A1	Revision
Drawing Number 80822047-CI-0002			5






DETERMINED by the NSW Land and Housing Corporation on:

8 March 2023

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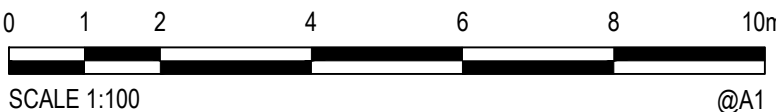
LEGEND

- DP DP - DOWN PIPE Ø100  
○ PBD PBD - PLANTER BED DRAIN Ø100  
[Symbol] OSD TANK  
[Symbol] STORMWATER PIT  
[Symbol] SEALED ACCESS PIT  
— DP — DOWN PIPE  
— SW — STORMWATER PIPE  
[Symbol] GD GRATED DRAIN  
NOTE:  
• LEGEND NOT TO SCALE

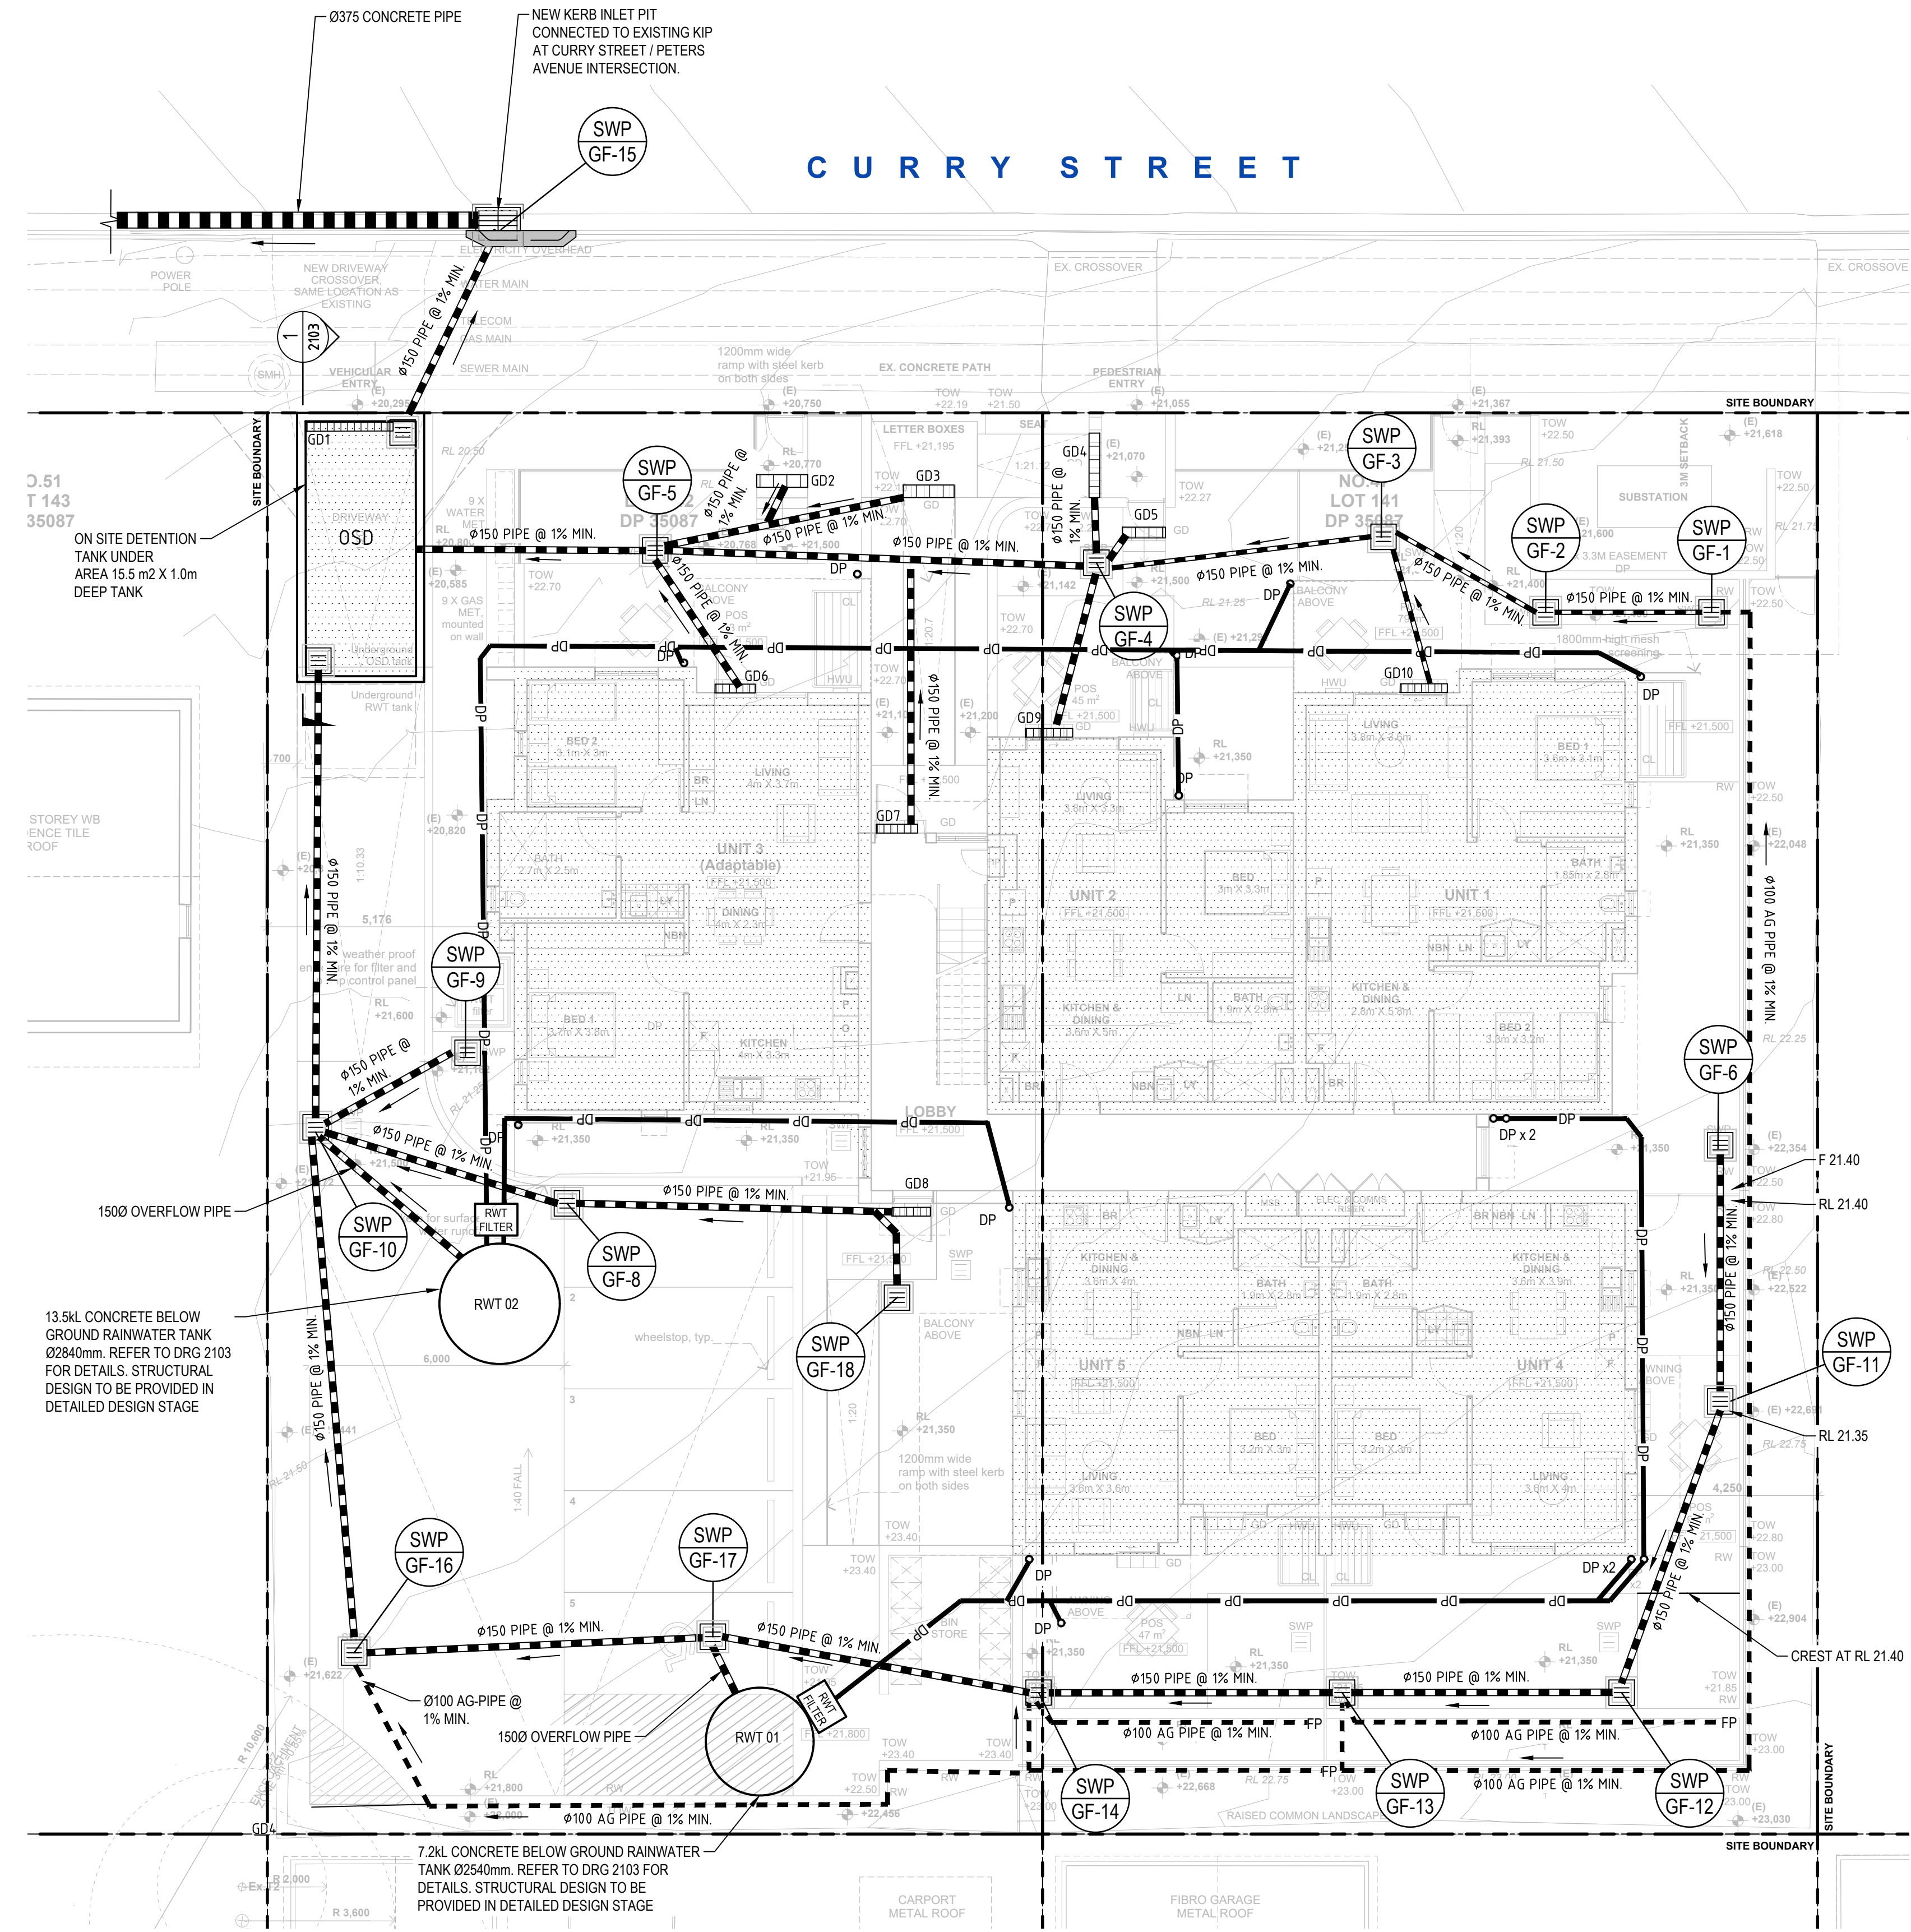

STORMWATER PIT SCHEDULE

SWP No.	PIT COVER LEVEL RL.	PIT INVERT LEVEL IL.	DEPTH (mm)	INTERNAL PIT SIZE	PIT TYPE	COVER TYPE	COVER CLASS	REMARKS
GF-1	21.6	21.15	450	450X450	SIP	GRATE	B	
GF-2	21.55	21.10	450	450 x 450	SIP	GRATE	B	
GF-3	21.4	20.95	450	450X450	SIP	GRATE	B	
GF-4	21.4	20.88	520	450 x 450	SIP	GRATE	B	
GF-5	21.4	20.78	620	600 x 600	SIP	GRATE	B	
GF-6	21.93	21.48	450	450 x 450	SIP	GRATE	B	
GF-8	21.5	20.94	560	450 x 450	SIP	GRATE	B	
GF-9	21.4	20.82	580	600X600	SIP	GRATE	B	
GF-10	21.5	20.49	1010	900 x 900	SIP	GRATE	C	
GF-11	21.30	20.90	450	450X450	SIP	GRATE	B	
GF-12	21.30	20.65	650	600X600	SIP	GRATE	B	
GF-13	21.30	20.74	560	450X450	SIP	GRATE	B	
GF-14	21.8	20.61	1191	900X900	SIP	GRATE	C	
GF-15	19.85	18.80	1050	900X450	KIP	GRATE	D	
GF-16	21.30	20.74	560	450X450	SIP	GRATE	B	
GF-17	21.85	20.57	1280	900X900	SIP	GRATE	B	
GF-18	21.30	20.90	400	450X450	SIP	GRATE	B	



Rev.	Date	Description	Des.	Verif.	Appd.
6	28/11/2022	REVISED ISSUE FOR DA APPROVAL	A.L	P.L	M.R
5	1/06/2022	REVISED ISSUE	K.P.	C.F.	
4	26/05/2022	REVISED ARCHITECTURAL BACKGROUND	K.P.	C.F.	
3	4/04/2022	REVISED ISSUE FOR DA APPROVAL	K.P.	C.F.	
2	7/03/2022	ISSUE FOR DA APPROVAL	K.P.	C.F.	
1	10/02/2021	PRELIMINARY ISSUE	K.P.	K.P.	C.F.

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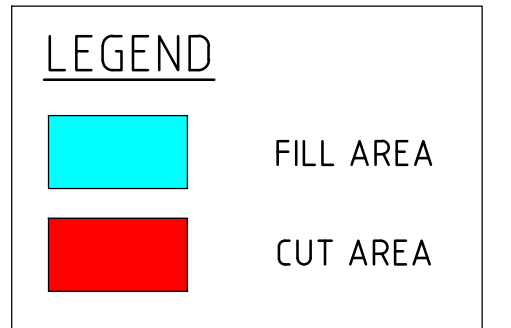


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Drawn K.P.	Date FEB' 2022	Client LAHC & SAMCRAWFORD ARCHITECTS
Checked K.P.	Date FEB' 2022	Project PROPOSED DEVELOPMENT AT
Designed K.P.	Date FEB' 2022	47-49 CURRY STREET
Verified C.F.	Date FEB' 2022	WALLSEND 2287
Approved		Title STORMWATER DRAINAGE PLAN GROUND FLOOR


Status FOR APPROVAL	Datum AHD	Scale 1:100	Size A1
NOT TO BE USED FOR CONSTRUCTION PURPOSES	Drawing Number 80822047-CI-1101	Revision 6	



[illegible]

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Checked K.P.	Date MAR/2022	Project PROPOSED DEVELOPMENT AT 47-49 CURRY STREET WALLSEND 2287	Status <b>FOR APPROVAL</b>		
Designed K.P.	Date MAR/2022		NOT TO BE USED FOR CONSTRUCTION PURPOSES		
Verified C.F.	Date MAR/2022	Title CUT AND FILL PLAN	Datum AHD	Scale 1:100	Size A1
Approved			Drawing Number 80822047-CI-1102		Revision 3

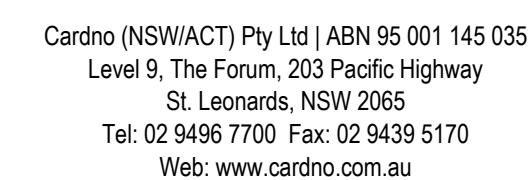


DATE PLOTTED: 28 November 2022 2:00 PM BY: ROCCO LARIA

XREFs: X-GROUND FLOOR - CUT AND FILL

CAD File: \\cardno-cop\global\AU\NSW\Directory\Structure\Projects\80822047-47-49 Curry Street Wallsend\012\_CIVIL\Drawings\Bulk\80822047-CI-1103.dwg

8 March 2023

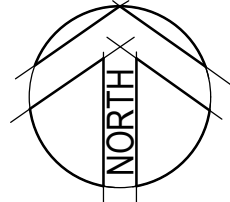

GRID	AVG EX	AVG PR	AVG DEPTH	CELL AREA	CELLL VOLUME	
	m	m	PR-EX	m2	m3	
A1	20.6875	22.79	2.1025	100	210.25	FILL
A2	21.0675	21.1425	0.075	100	7.5	FILL
A3	21.4725	21.2425	-0.23	100	-23	CUT
A4	21.765	21.597	-0.168	65.76	-11.04768	CUT
B1	21.15	23.51	2.36	100	236	FILL
B2	21.575	21.3	-0.275	100	-27.5	CUT
B3	21.9875	21.3	-0.6875	100	-68.75	CUT
B4	22.2125	21.7505	-0.462	65.76	-30.38112	FILL
C1	21.6275	21.425	-0.2025	100	-20.25	CUT
C2	22.115	21.3625	-0.7525	100	-75.25	CUT
C3	22.5125	21.325	-1.1875	100	-118.75	CUT
C4	22.6875	21.9895	-0.698	65.76	-45.90048	CUT
D1	21.935	21.8175	-0.1175	35.28	-4.1454	CUT
D2	22.4425	21.9255	-0.517	35	-18.095	CUT
D3	22.795	22.088	-0.707	35.28	-24.94296	CUT
D4	23.005	22.5835	-0.4215	23.2	-9.7788	CUT

CUT VOLUME =	-477.791 m3
FILL VOLUME =	453.75 m3
BAL =	-24.0414 m3 CUT REQUIRED



BULK EARTHWORK LEVEL  
SCALE 1:100



3	28/11/2022	REVISED ISSUE FOR DA APPROVAL	AL	P.L	M.R
2	1/06/2022	REVISED ISSUE	K.P.	C.F.	
1	21/03/2022	PRELIMINARY ISSUE	K.P.	K.P.	C.F.
Rev.	Date	Description	Des.	Verif.	Appd.

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Checked K.P.	Date MAR'2022	Project PROPOSED DEVELOPMENT AT 47-49 CURRY STREET WALLSEND 2287
Designed K.P.	Date MAR'2022	Title BULK EARTHWORK LEVEL
Verified C.F.	Date MAR'2022	Status <b>FOR APPROVAL</b> NOT TO BE USED FOR CONSTRUCTION PURPOSES
Approved		Datum AHD
		Scale 1:100
		Size A1
		Drawing Number 80822047-CI-1103
		Revision 3




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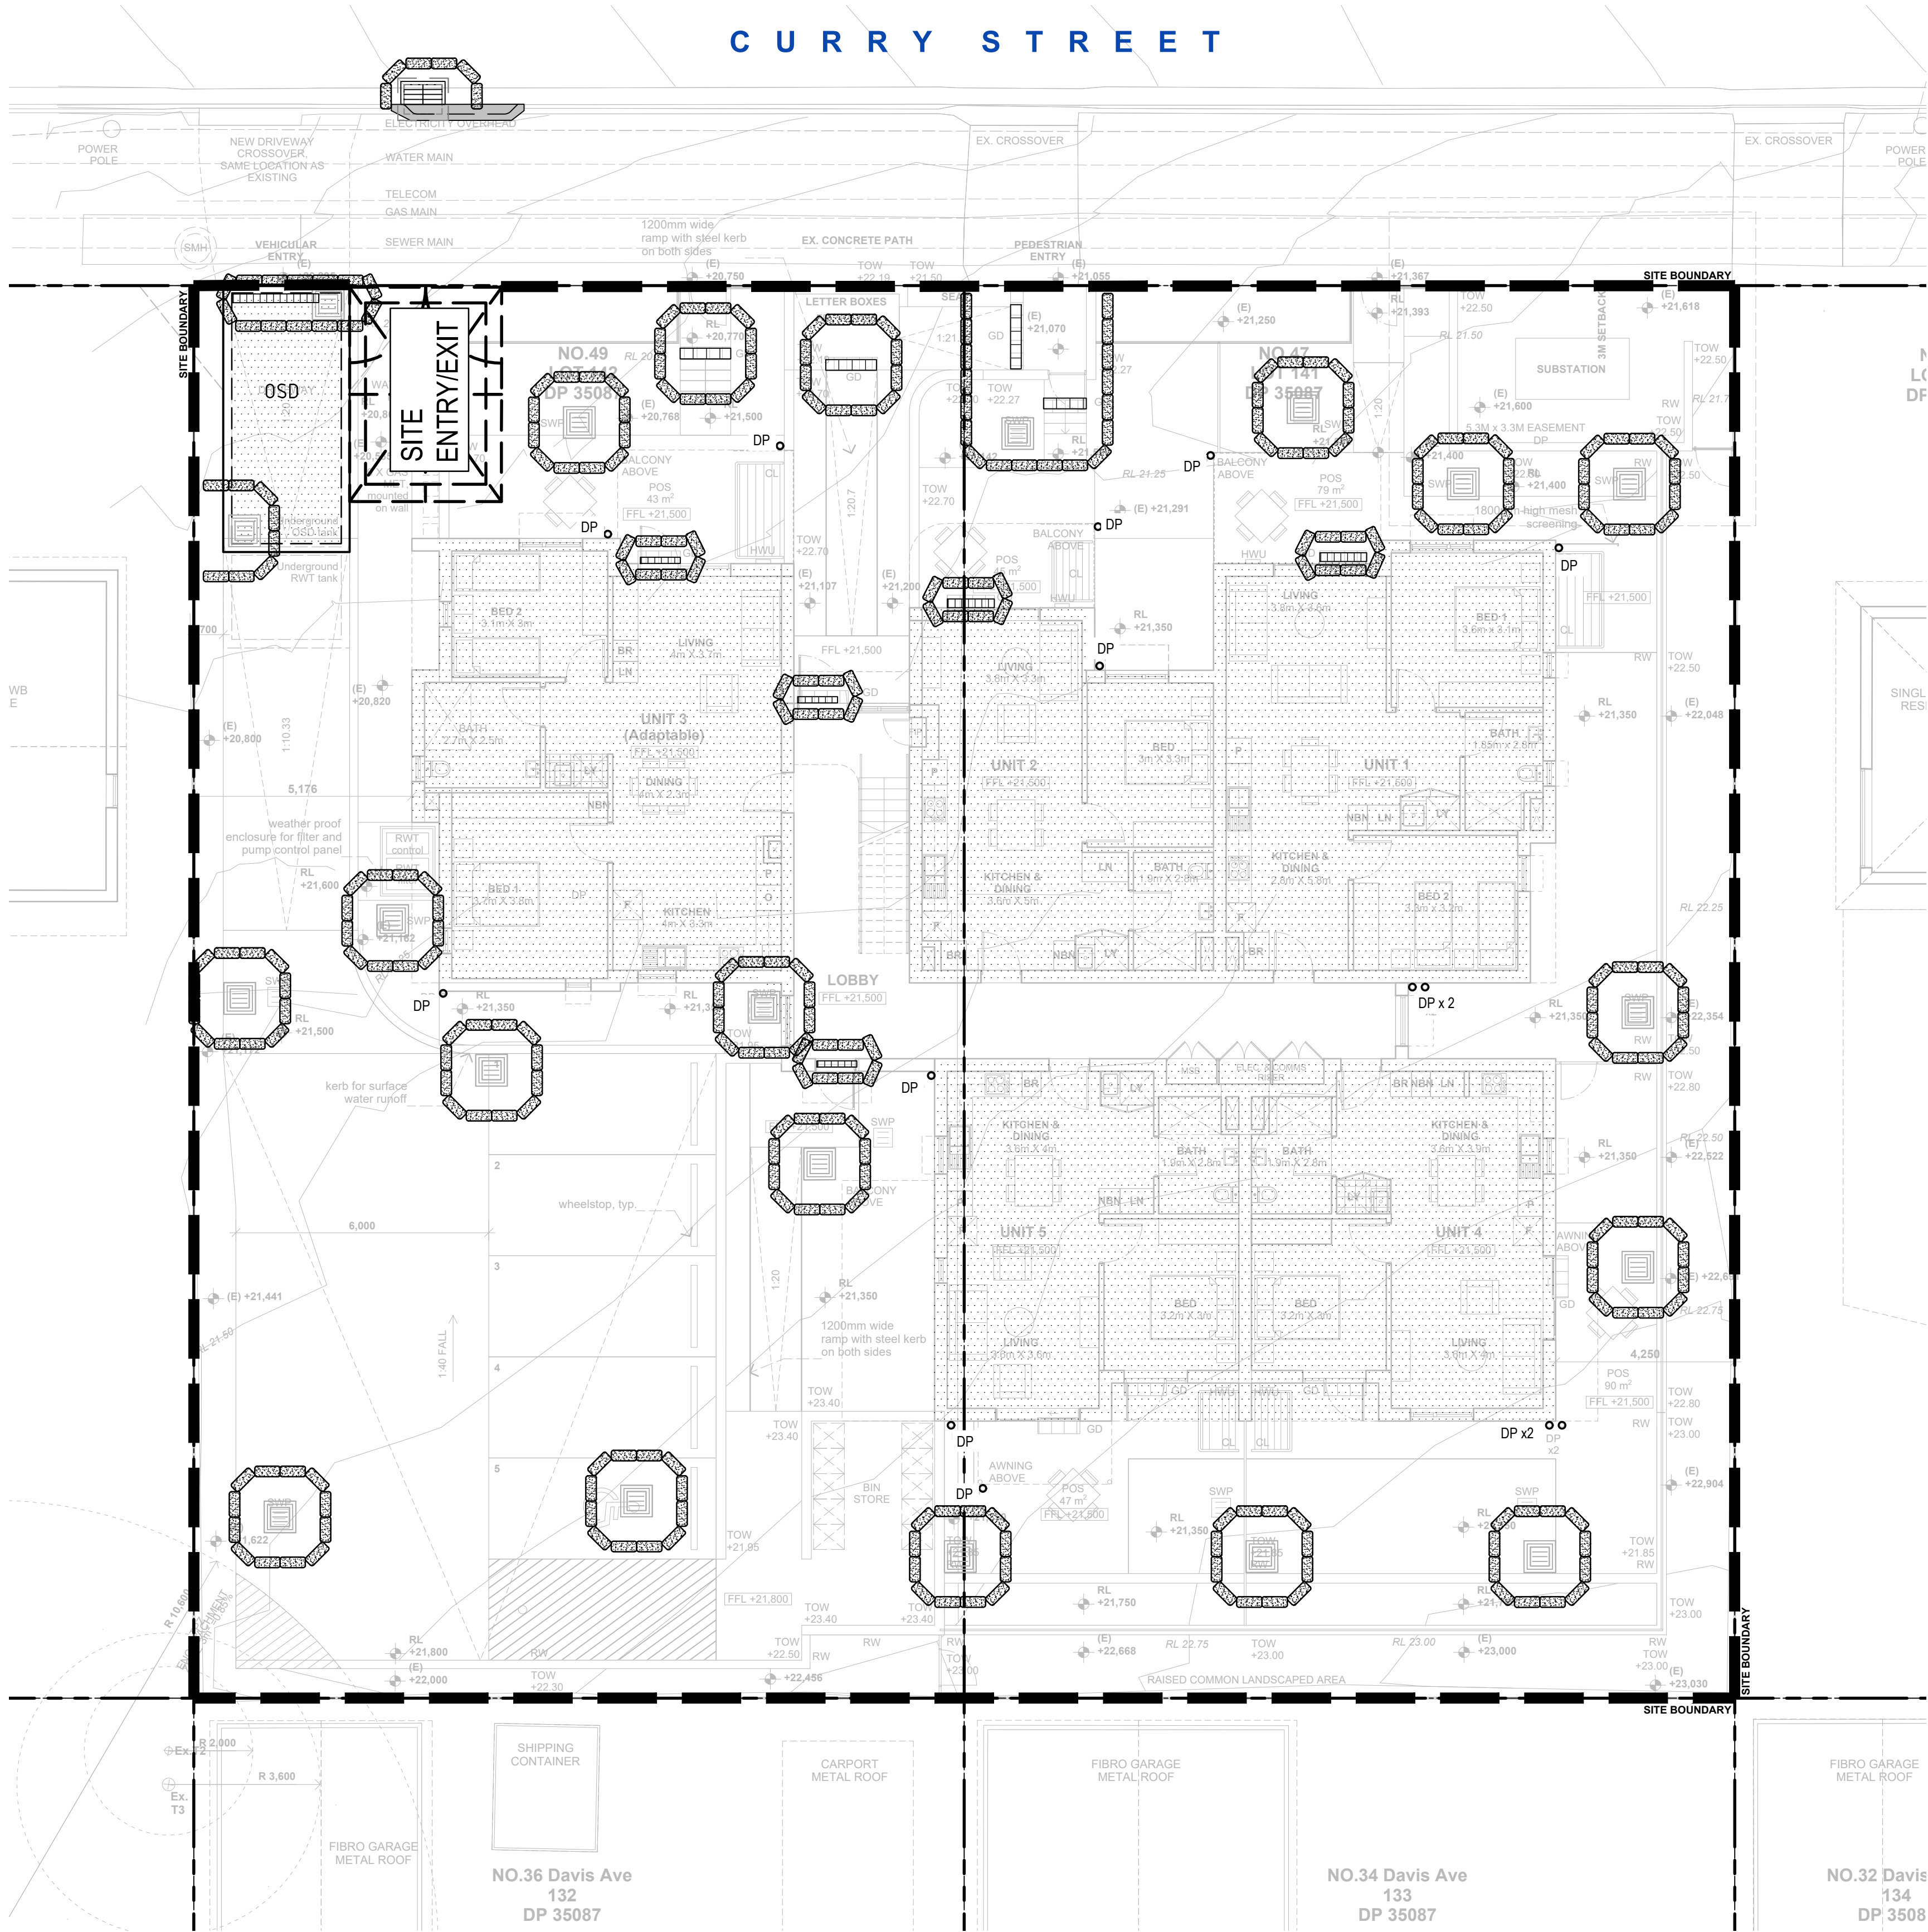
XREFs: X-GROUND FLOOR  
CAD File: \\cardno\proj\001\AU\NSW\Drawings\Bldg\80822047-CI-1201.dwg

DETERMINED by the NSW Land and Housing Corporation on:  
8 March 2023

*Cardno*

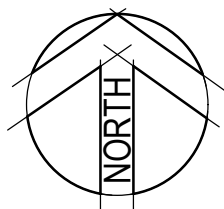

CURRY STREET



## LEGEND

- SITE FENCE
- SILT FENCE
- STORMWATER PIT
- SEALED ACCESS PIT
- SILT TRAP/SAND BAGS
- TEMPORARY SURFACE INLET SEDIMENT TRAP OR GROSS POLLUTANT TRAP
- TEMPORARY CONSTRUCTION VEHICLE ENTRY/EXIT

## NOTE

SITE ACCESS AND STOCKPILE LOCATION MAY CHANGE DEPENDING ON CONSTRUCTION PREFERENCE

FOR SEDIMENTATION AND EROSION CONTROL DETAILS REFER TO DRAWING 80822047-CI-2201.

THIS LAYOUT PRESENTS ONE OF A NUMBER OF POSSIBLE SOLUTIONS FOR THE EROSION AND SEDIMENTATION CONTROL ON THE SITE DURING THE CONSTRUCTION PERIOD. FINAL LAYOUT MAY BE ALTERED BY THE CONTRACTOR TO SUIT THEIR SITE LAYOUT, OPERATIONS SEQUENCE, STAGING ETC. ANY SUCH CHANGES MUST BE IN ACCORDANCE WITH THE GUIDELINES OF LANDCOM MANAGING URBAN STORMWATER MANUAL. 2004 ("BLUE BOOK") SHOULD THE STRIPPED AREA AT ANY STAGE EXCEED 2500 m<sup>2</sup>, SEDIMENTATION POND INCL. ASSOCIATED BERMS, CUT OFF TRENCHES ETC. IS TO BE PROVIDED IN ACCORDANCE WITH THE GUIDELINES OF LANDCOM MANAGING URBAN STORMWATER MANUAL.



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Drawn G.M.	Date FEB' 2022	Client LAHC & SAMCRAWFORD ARCHITECTS
Checked K.P.	Date FEB' 2022	
Designed G.M.	Date FEB' 2022	Project PROPOSED DEVELOPMENT AT 47-49 CURRY STREET WALLSEND 2287
Verified C.F.	Date FEB' 2022	Title SEDIMENTATION AND EROSION CONTROL
Approved		

Status <b>FOR APPROVAL</b>	
Datum AHD	Scale 1:100
Drawing Number 80822047-CI-1201	Size A1
Revision 6	

Rev.	Date	Description	Des.	Verif.	Appd.
6	28/11/2022	REVISED ISSUE FOR DA APPROVAL	A.L.	P.L.	M.R.
5	1/06/2022	REVISED ISSUE	K.P.	C.F.	
4	26/05/2022	REVISED ARCHITECTURAL BACKGROUND	K.P.	C.F.	
3	4/04/2022	REVISED ISSUE FOR DA APPROVAL	K.P.	C.F.	
2	7/03/2022	ISSUE FOR DA APPROVAL	K.P.	C.F.	
1	10/02/2021	PRELIMINARY ISSUE	G.M.	K.P.	C.F.




DATE PLOTTED: 28 November 2022 2:00 PM BY: ROCCO LARIA


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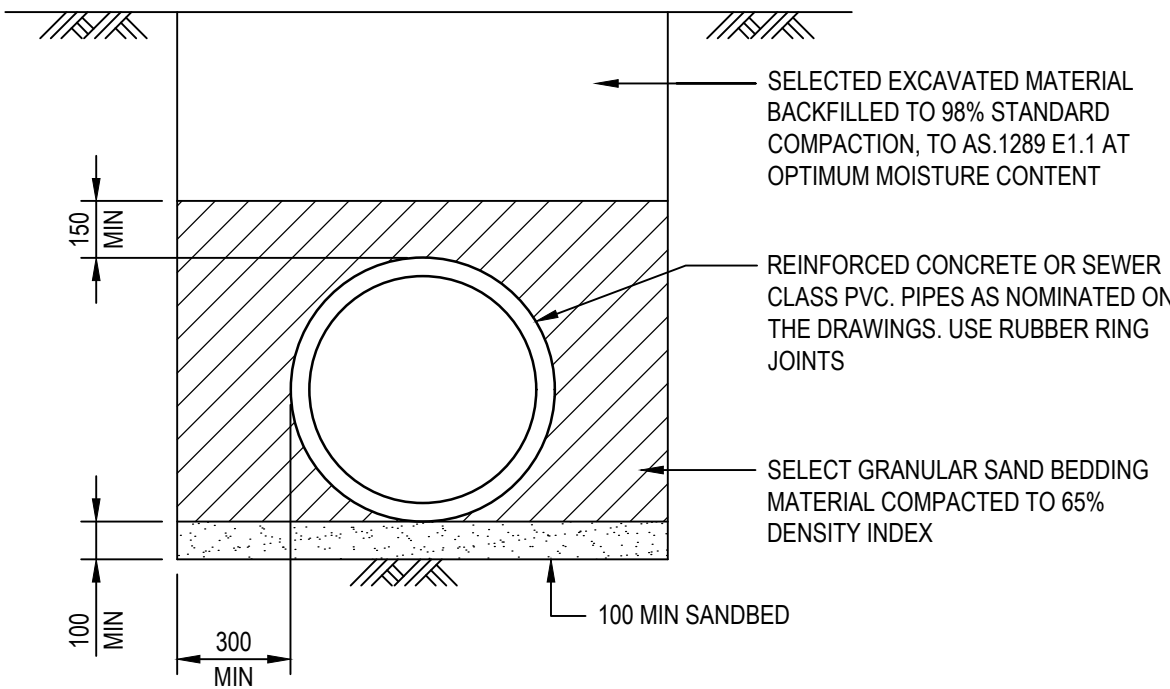
*Shadr*



HIGH END RISER  
N.T.S.

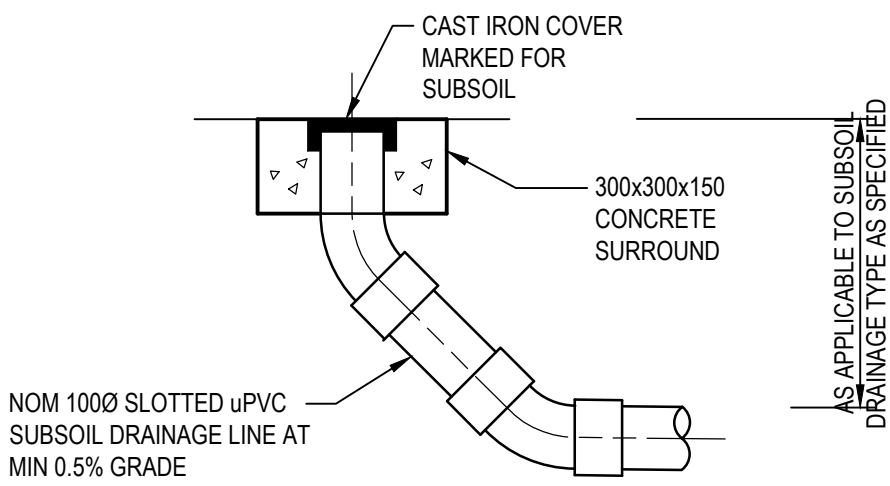


INTERMEDIATE RISER  
N.T.S.  
(TYPICAL AT 25m. INTERVALS UNLESS OTHERWISE NOTED ON PLAN)

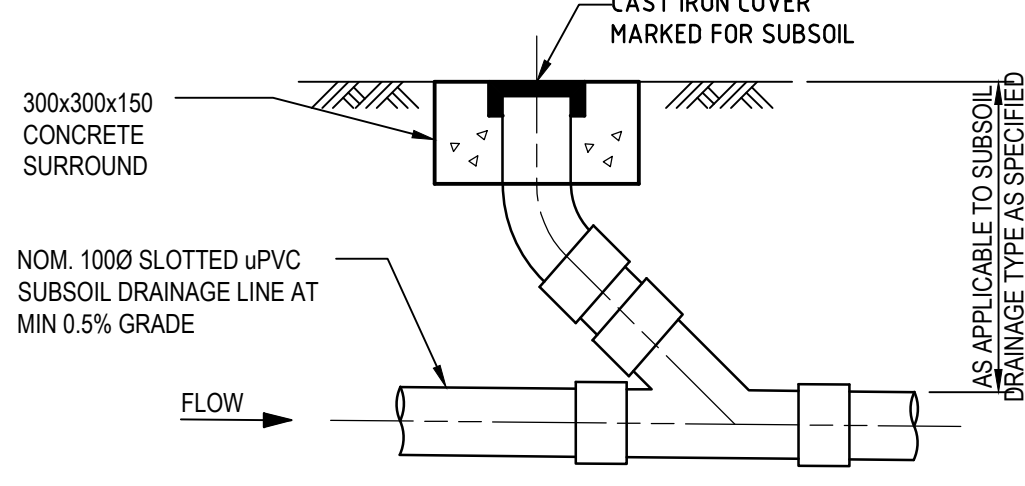


TYPICAL PIPE LAYING DETAIL U.N.O.


NOTE:  
ALLOW TO BUILD 1000 AG. DRAIN IN THE LAST 3.0m OF DRAINAGE PIPE, UPSTREAM OF ALL DRAINAGE PITS.

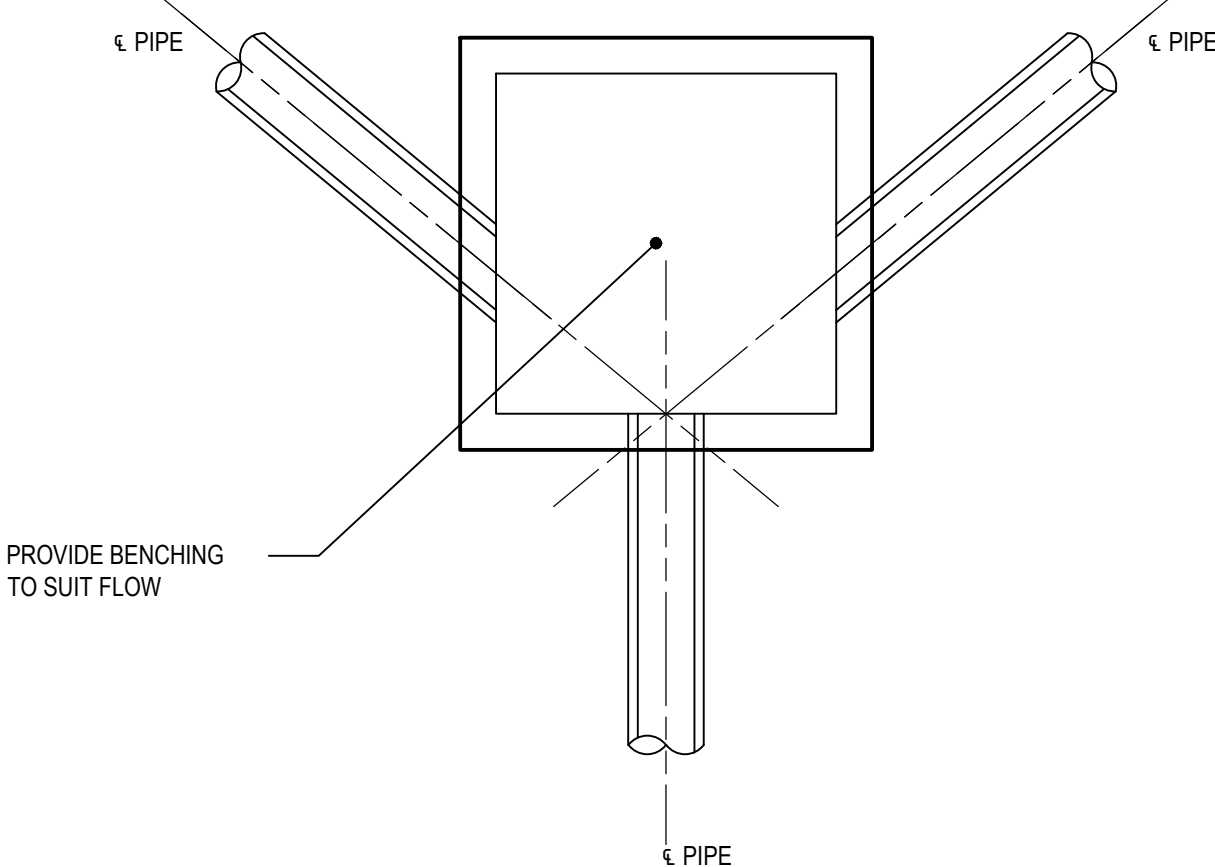


JUNCTION PIT SET OUT DETAILS  
N.T.S.

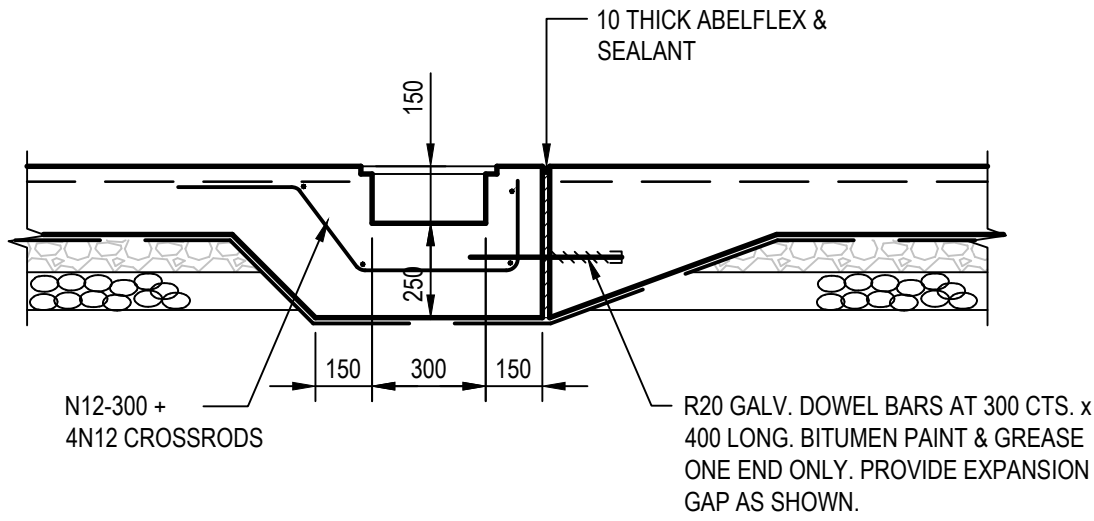


GRATED DRAIN DETAIL  
SCALE 1:20

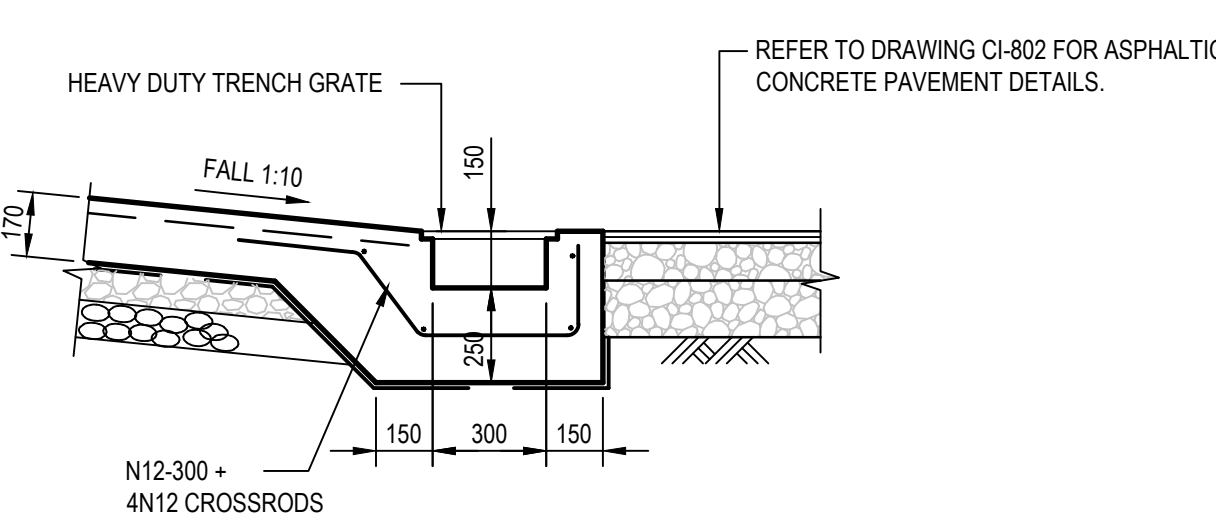


GRATED DRAIN DETAIL AT ENTRY ROAD  
SCALE 1:20

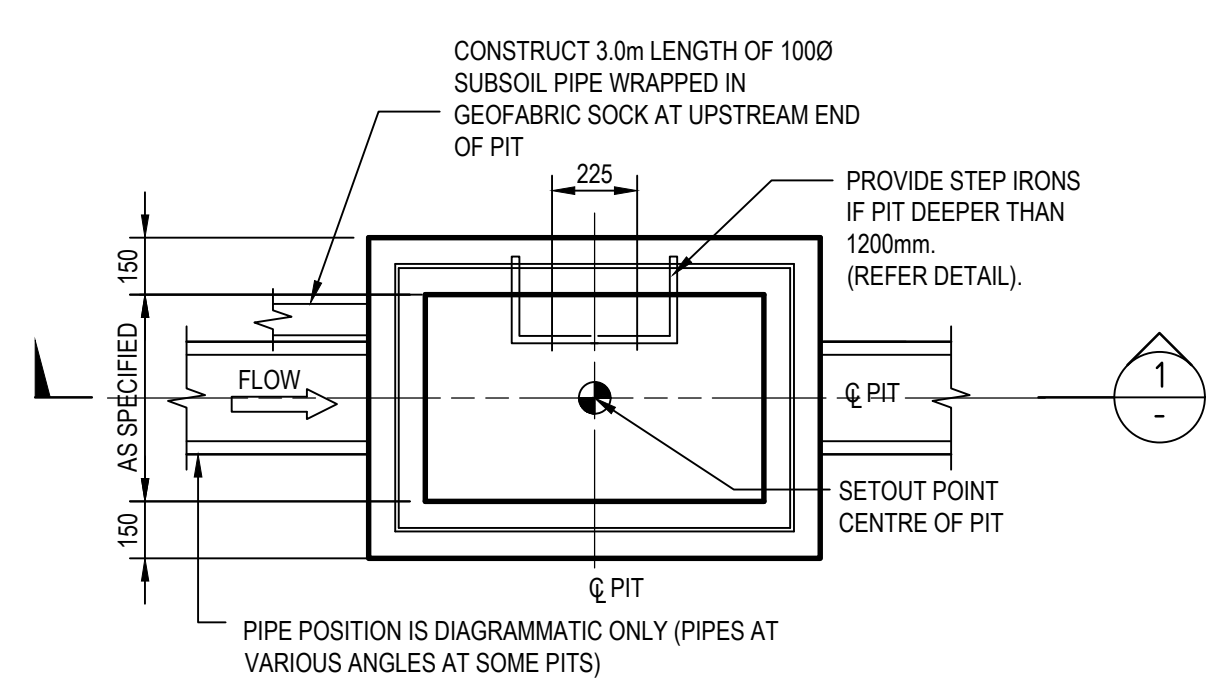


PLAN  
N.T.S.

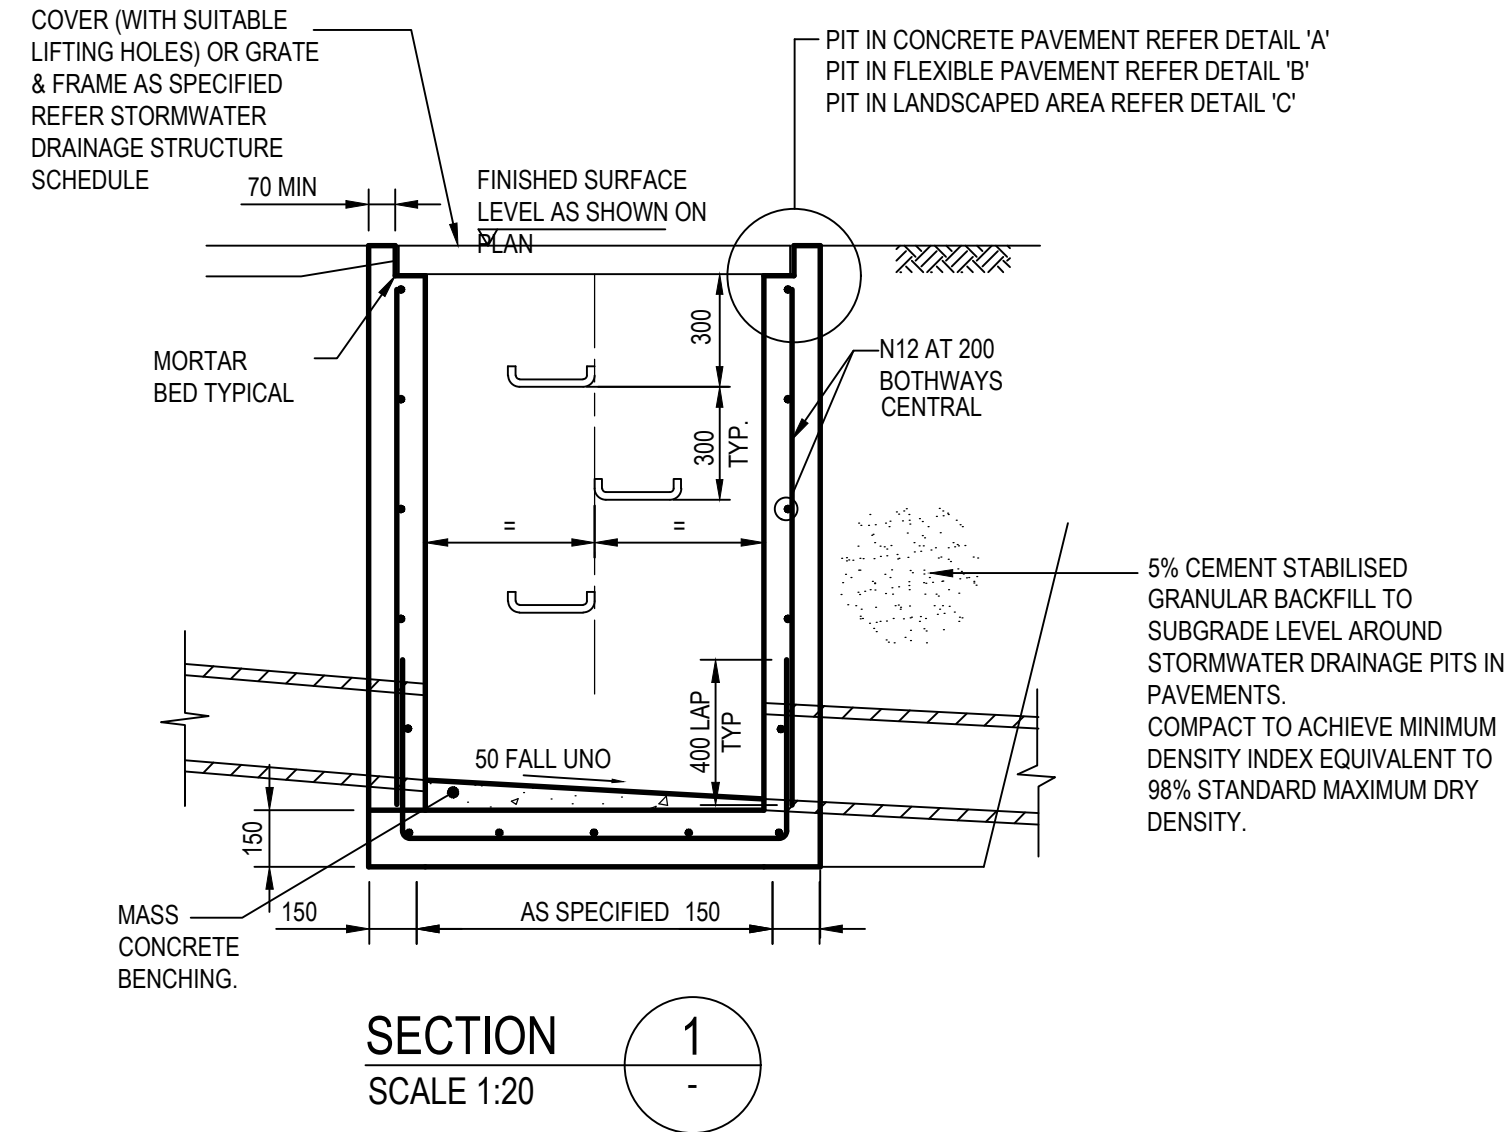


SURFACE INLET/JUNCTION PIT (SIP/JP)  
SCALE 1:20

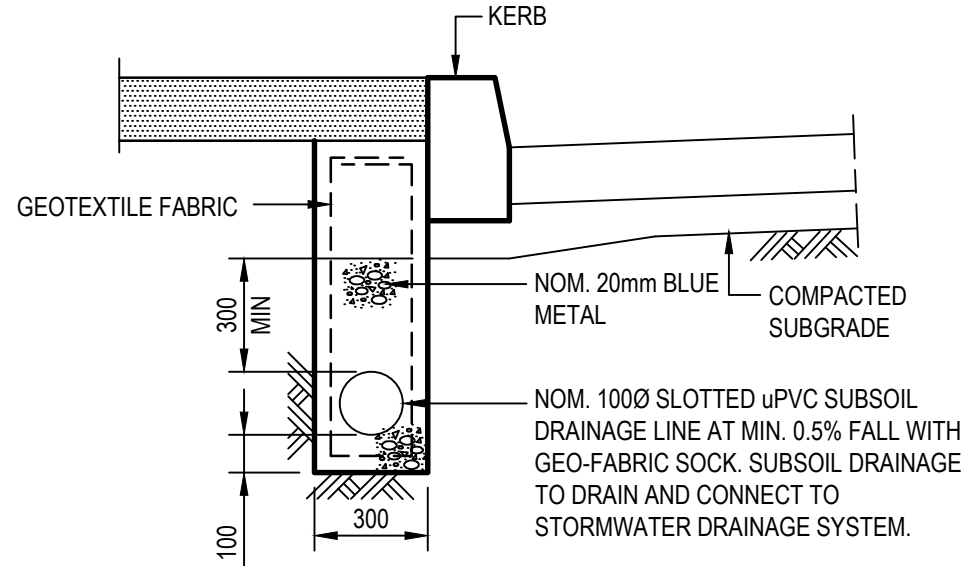

SUBSOIL DRAINAGE LINE IN LANDSCAPED  
AREAS ADJACENT TO ROADS

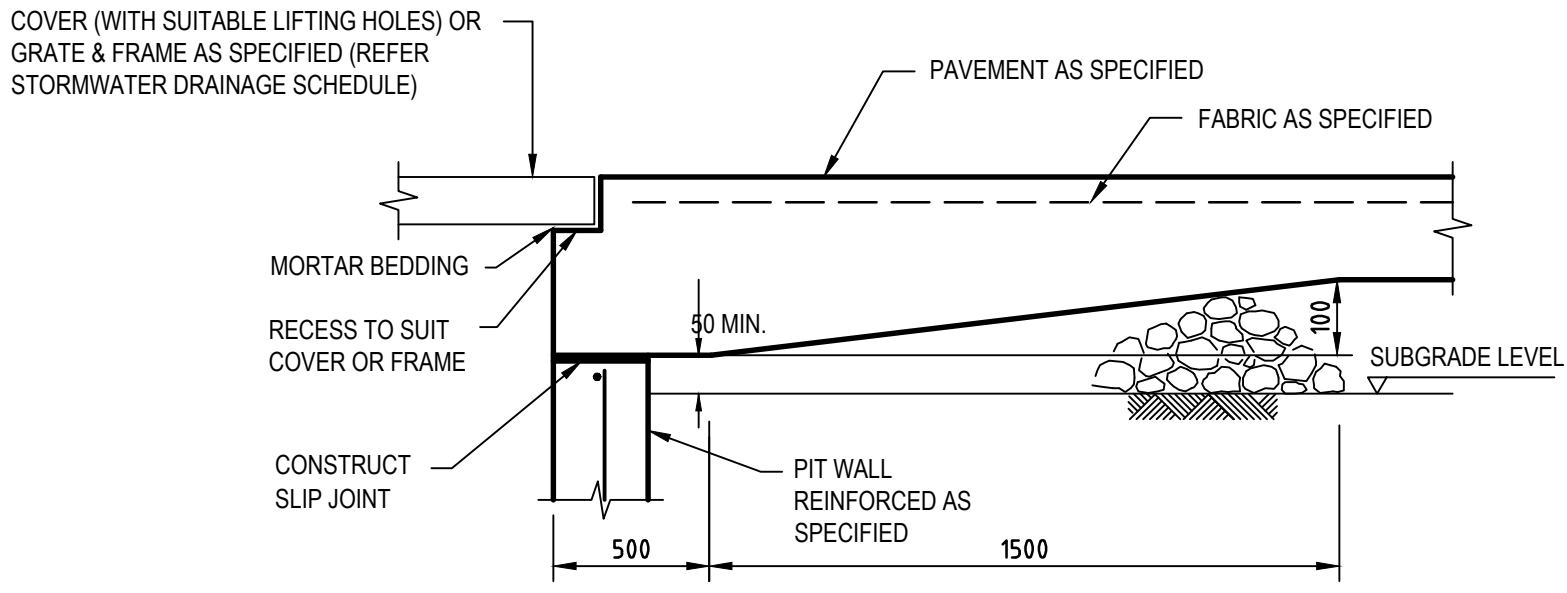


DETAIL "A"  
N.T.S.

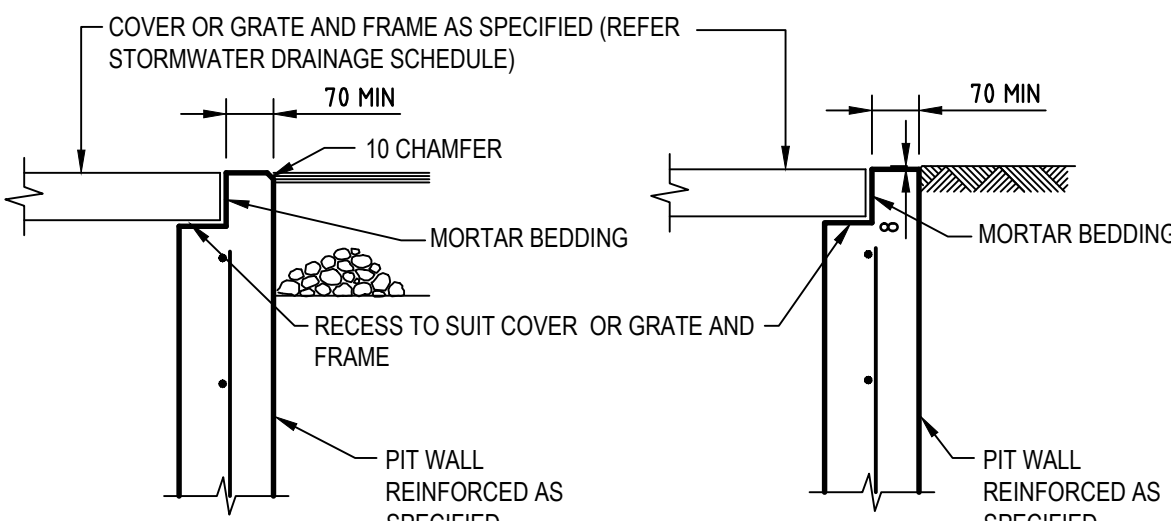

DETAIL "B"  
SCALE 1:10

DETAIL "C"  
SCALE 1:10

PIT EDGE TREATMENT FOR STORMWATER DRAINAGE AND OTHER SERVICES PITS  
IN ROAD PAVEMENTS AND LANDSCAPED AREAS

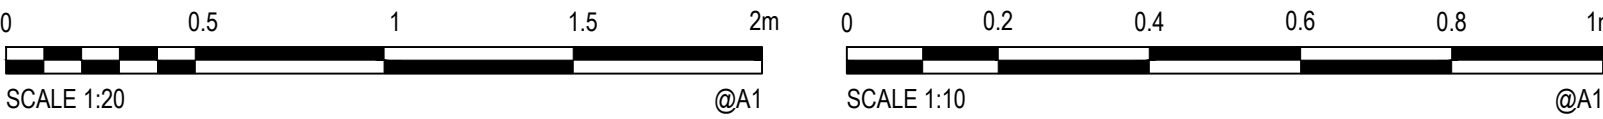

XREF's:

CAD File: \\cardno\cpg\ba\AU\NSW\Drawings\Build\80822047-CI-2101.dwg

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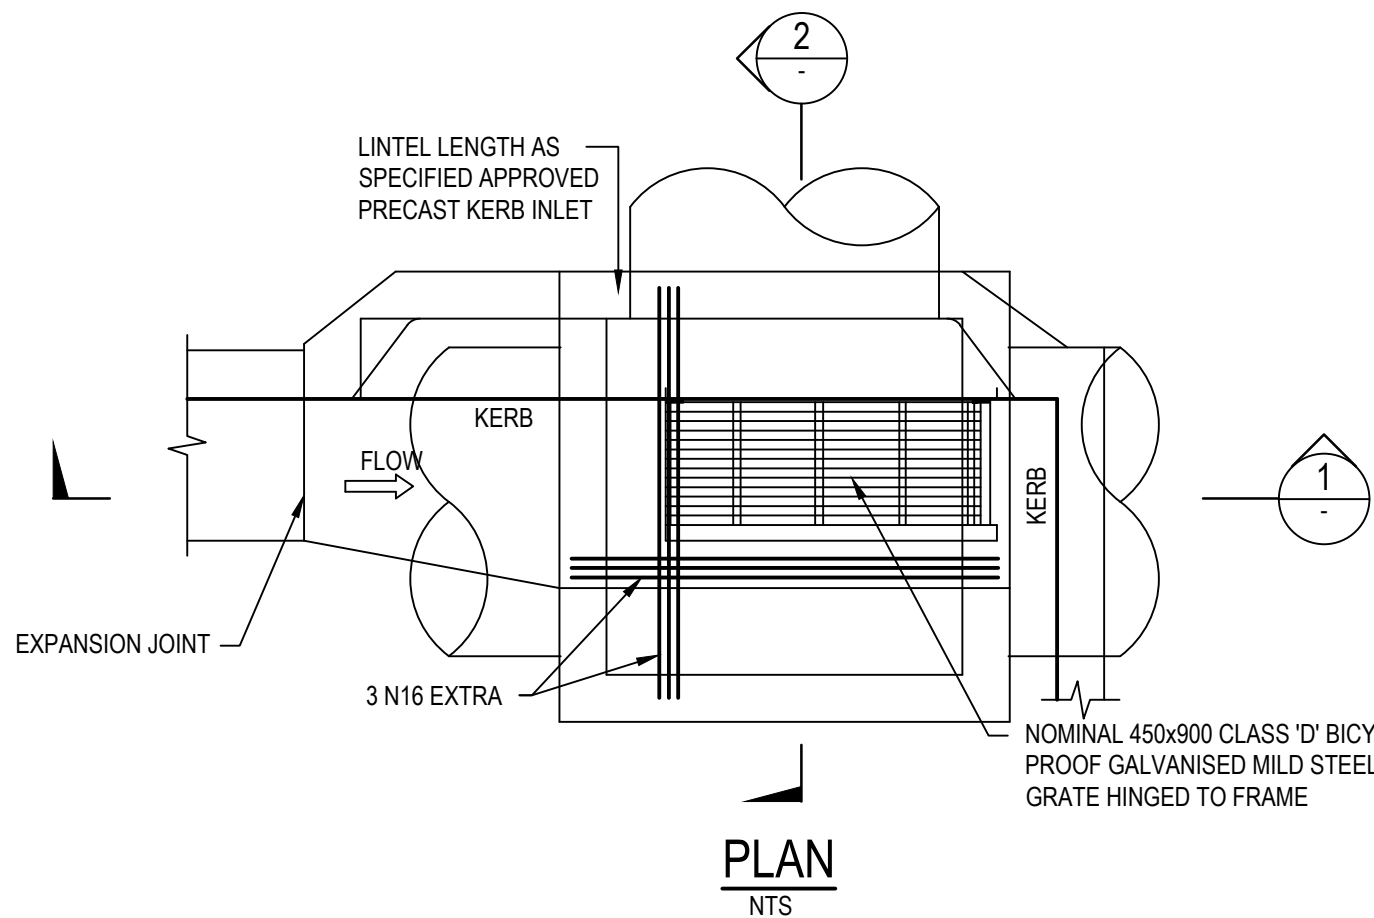
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Verified C.F. Date FEB' 2022  
Approved  
Client LAHC & SAMCRAWFORD ARCHITECTS  
Project PROPOSED DEVELOPMENT AT  
47-49 CURRY STREET  
WALLSEND 2287  
Title STORMWATER DETAILS  
SHEET 1


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NOT TO BE USED FOR CONSTRUCTION PURPOSES  
Datum AHD Scale AS SHOWN Size A1  
Drawing Number 80822047-CI-2101 Revision 5




DATE PLOTTED: 28 November 2022 2:01 PM BY: ROCCO LARIA




KERB INLET PIT (KIP-A)  
(CORNER)

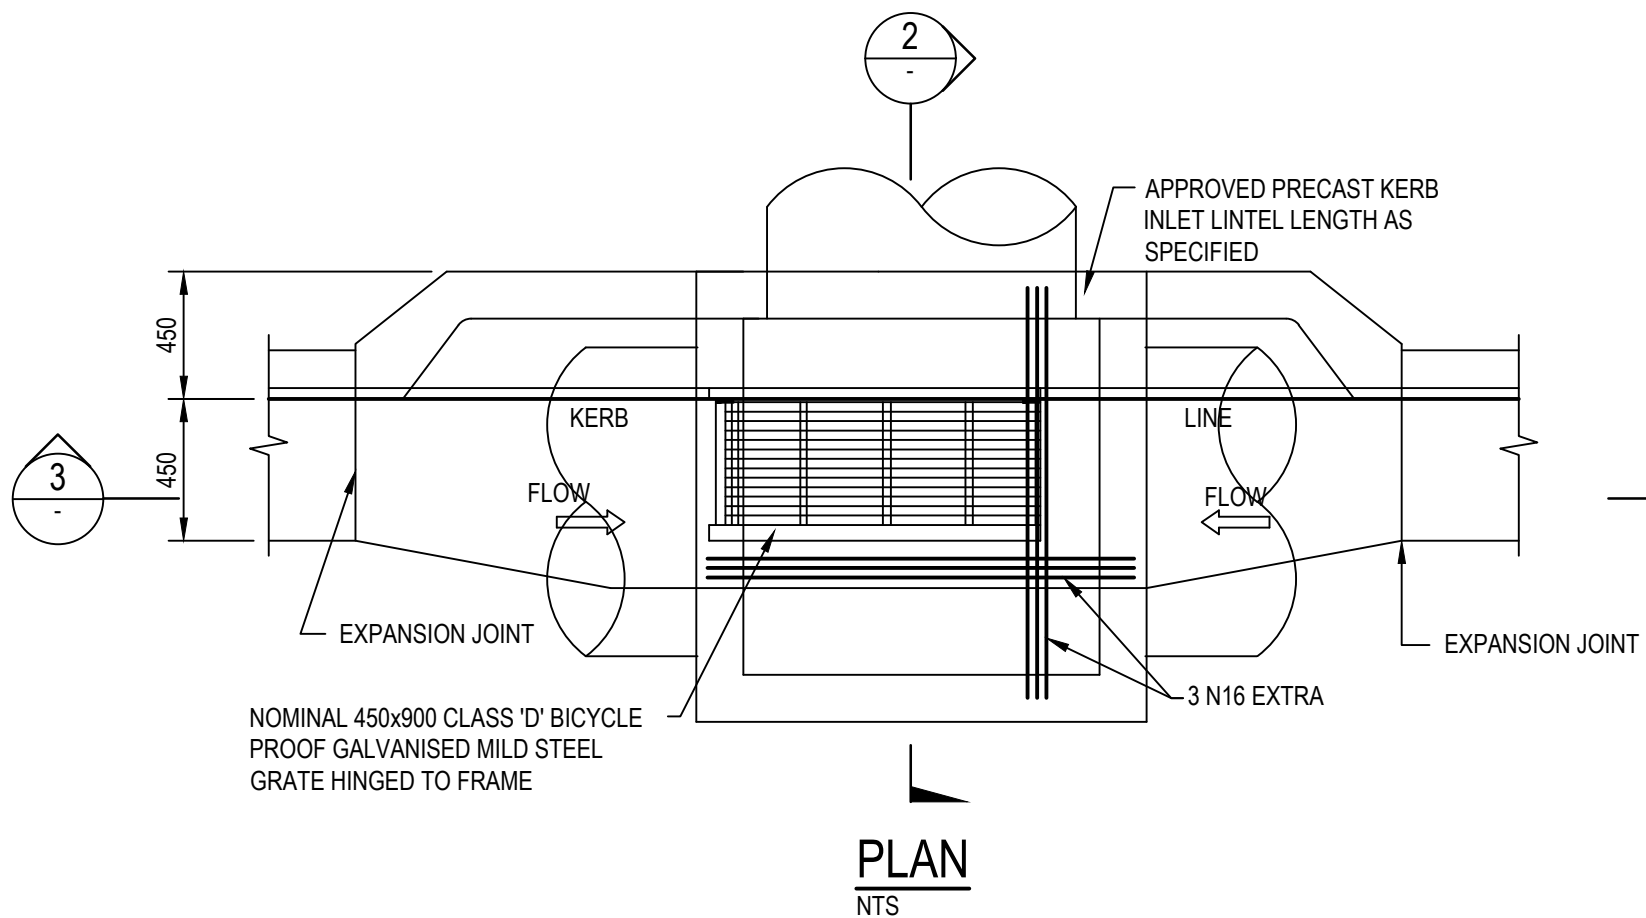


KERB INLET PIT (KIP-B)  
(SAG)

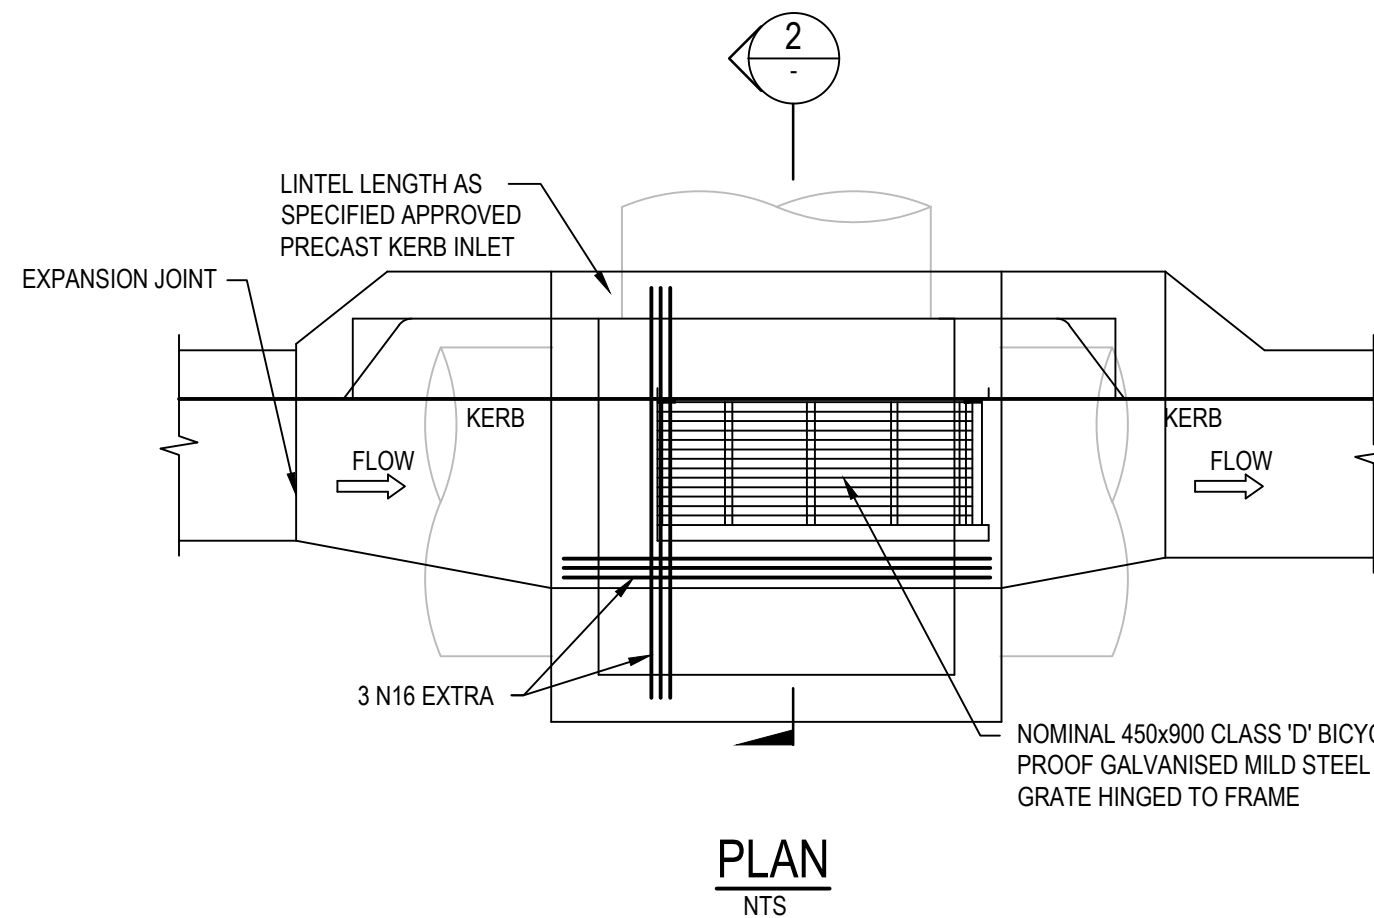


KERB INLET PIT (KIP-C)  
(ON GRADE)

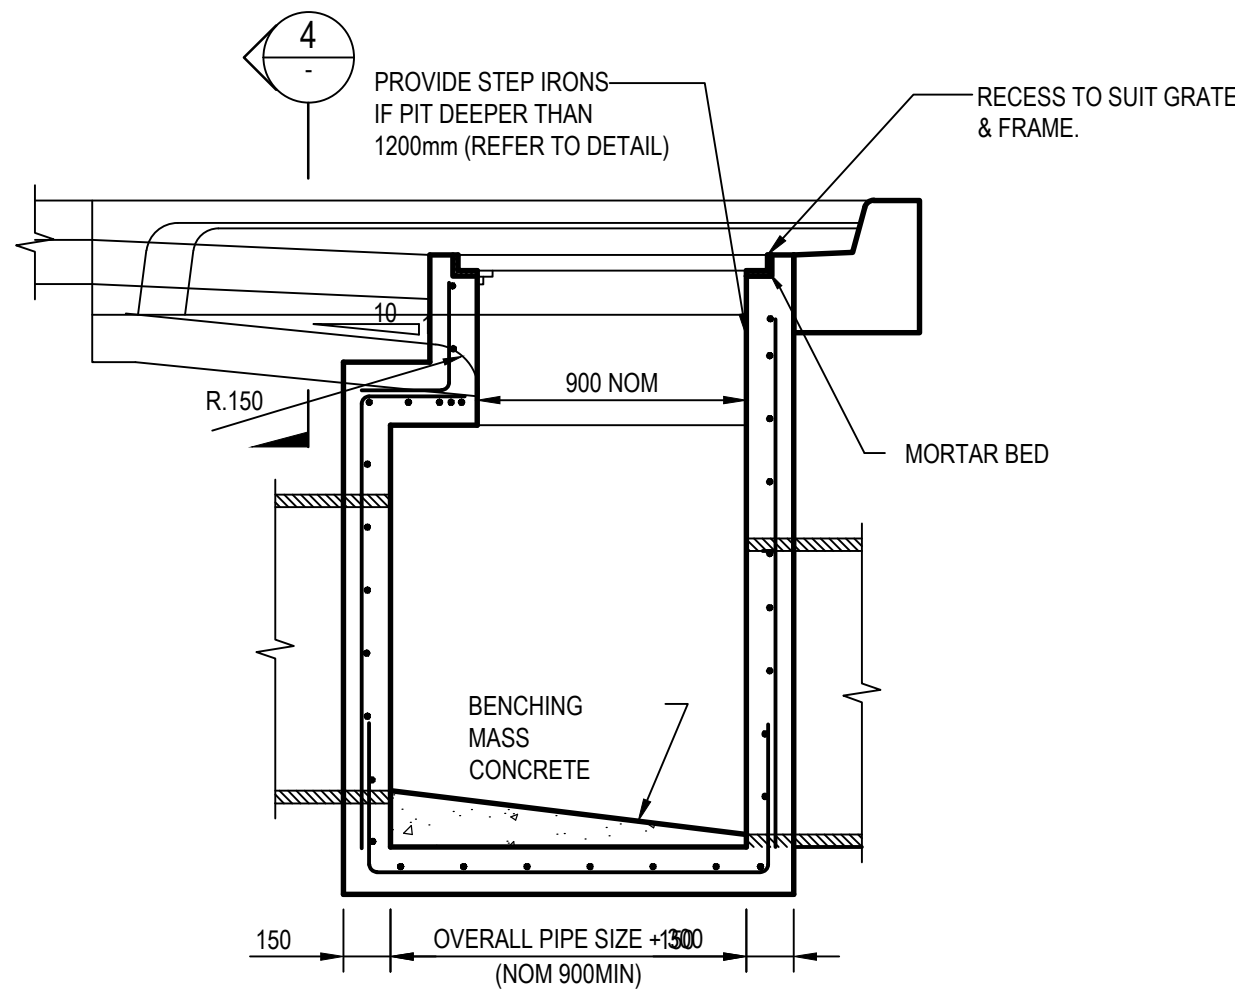


SECTION 1  
SCALE 1:20

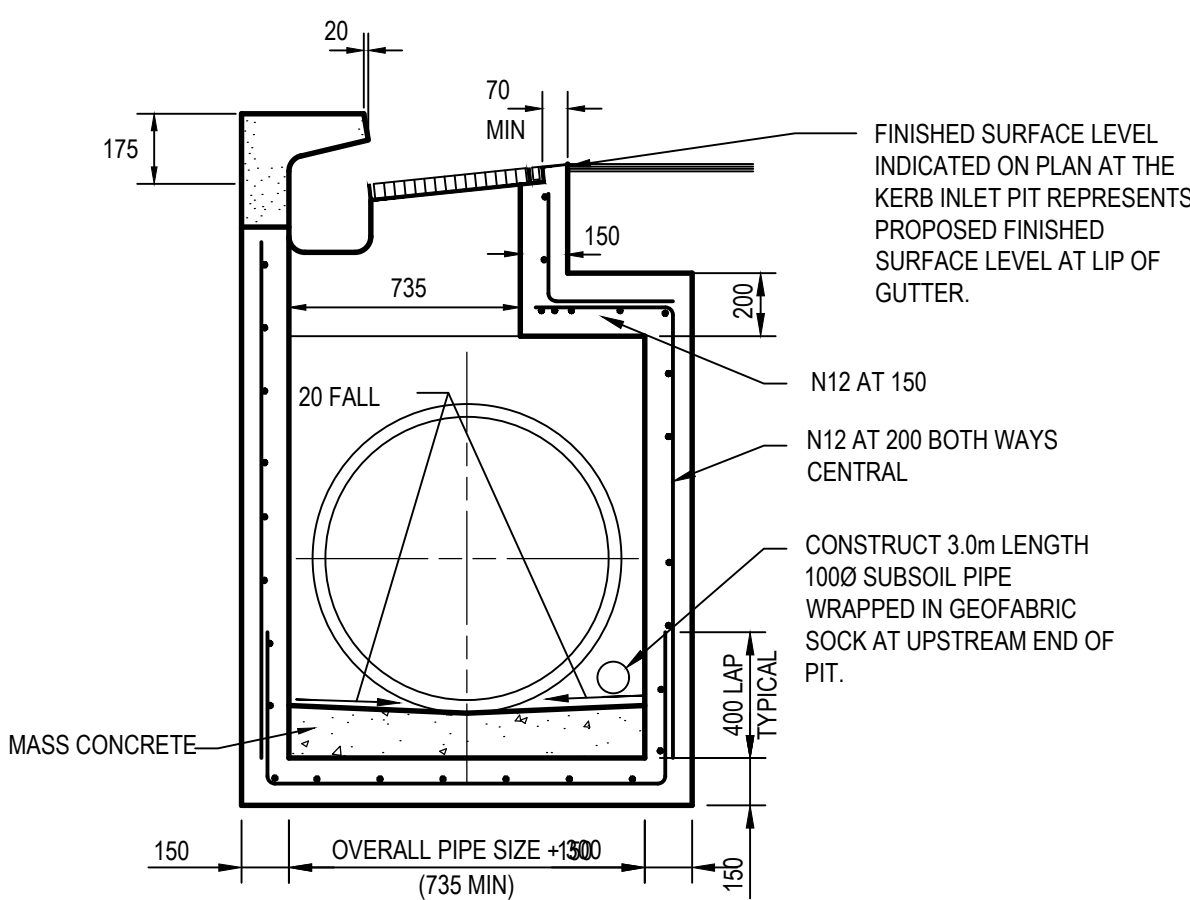


SECTION 2  
SCALE 1:20

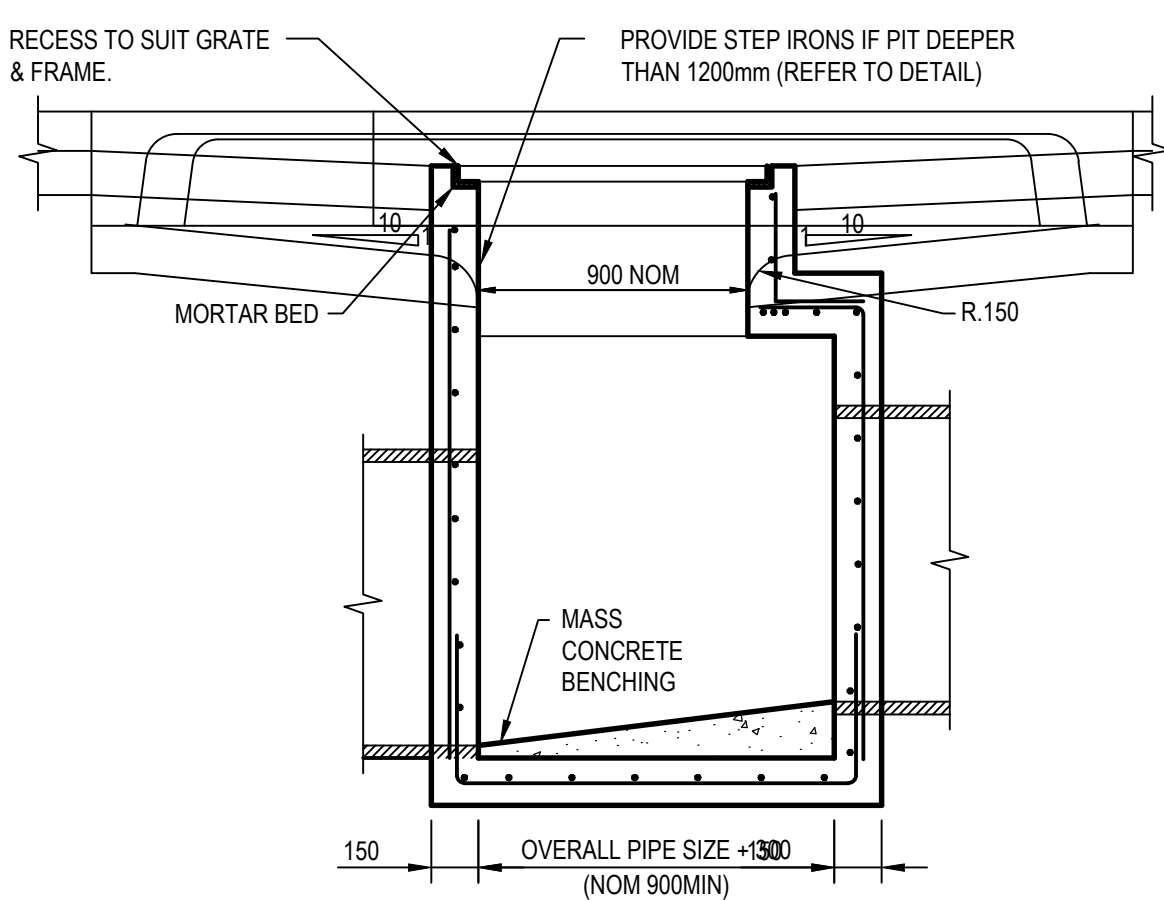


SECTION 3  
SCALE 1:20

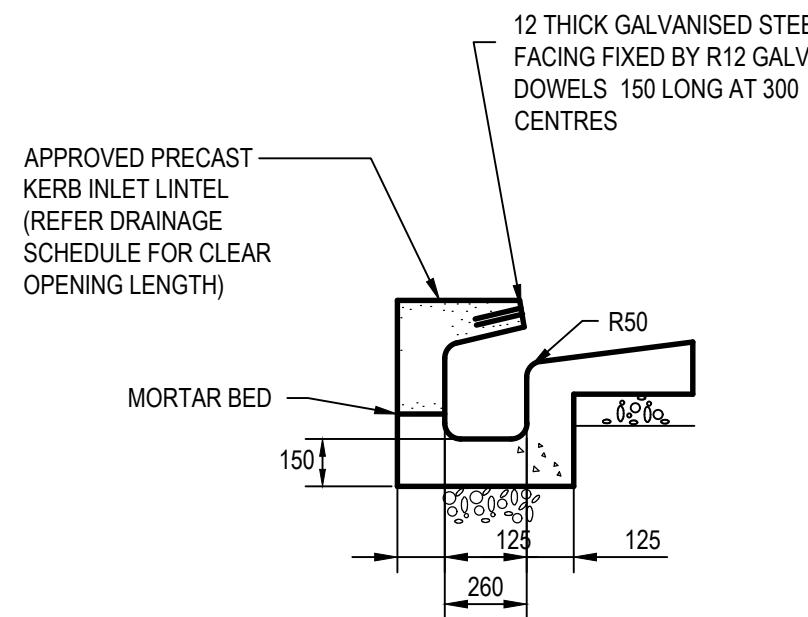

SECTION 4  
SCALE 1:20

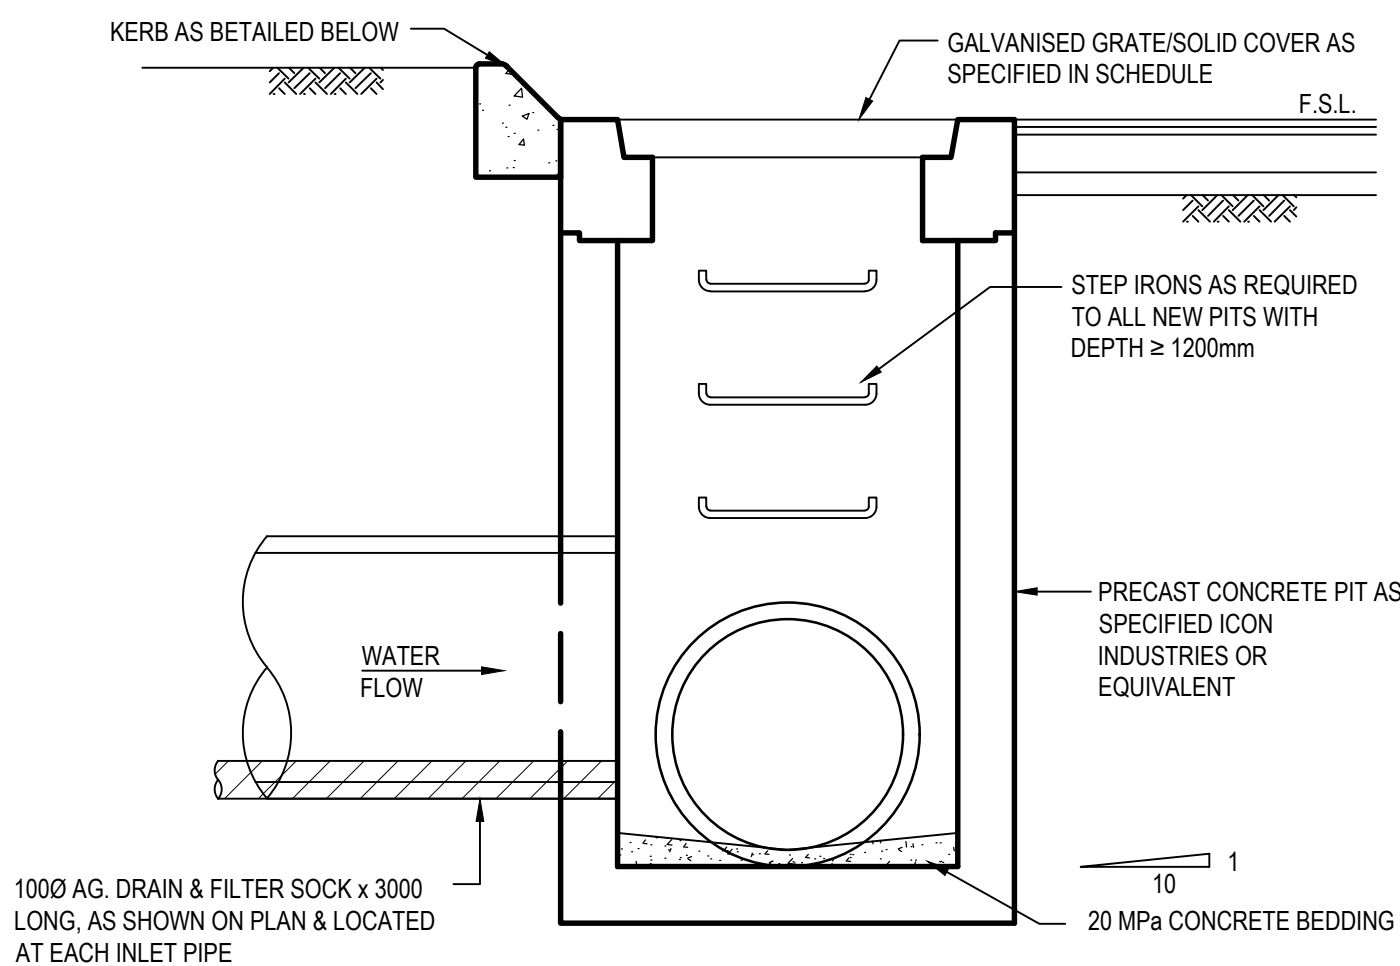

PRECAST STORMWATER PIT  
TO BE INSTALLED AND BEDDED IN ACCORDANCE WITH MANUFACTURERS RECOMMENDATIONS. PROVIDE GALVANISED IRON STEP IRONS EPOXIED INTO CONCRETE FOR PITS DEEPER THAN 1200mm.

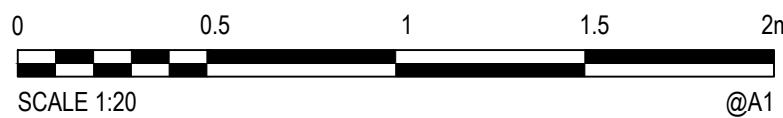

XREFs:

Rev.	Date	Description	Des.	Verif.	Appd.
5	28/11/2022	REVISED ISSUE FOR DA APPROVAL	A.L.	P.L.	M.R.
4	1/06/2022	REVISED ISSUE	K.P.	C.F.	
3	4/04/2022	REVISED ISSUE FOR DA APPROVAL	K.P.	C.F.	
2	7/03/2022	ISSUE FOR DA APPROVAL	K.P.	C.F.	
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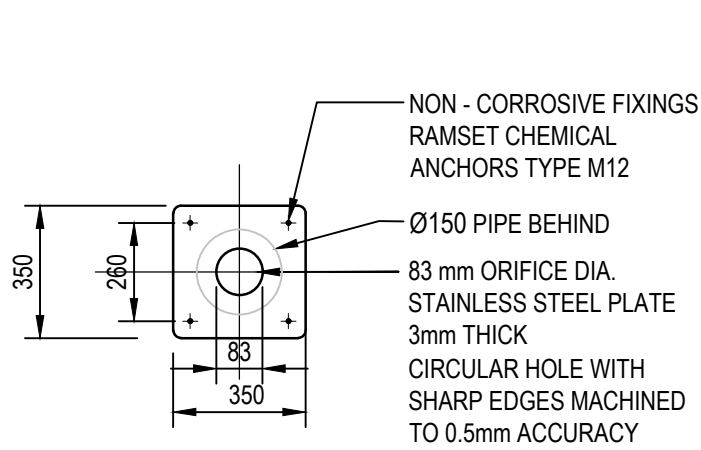
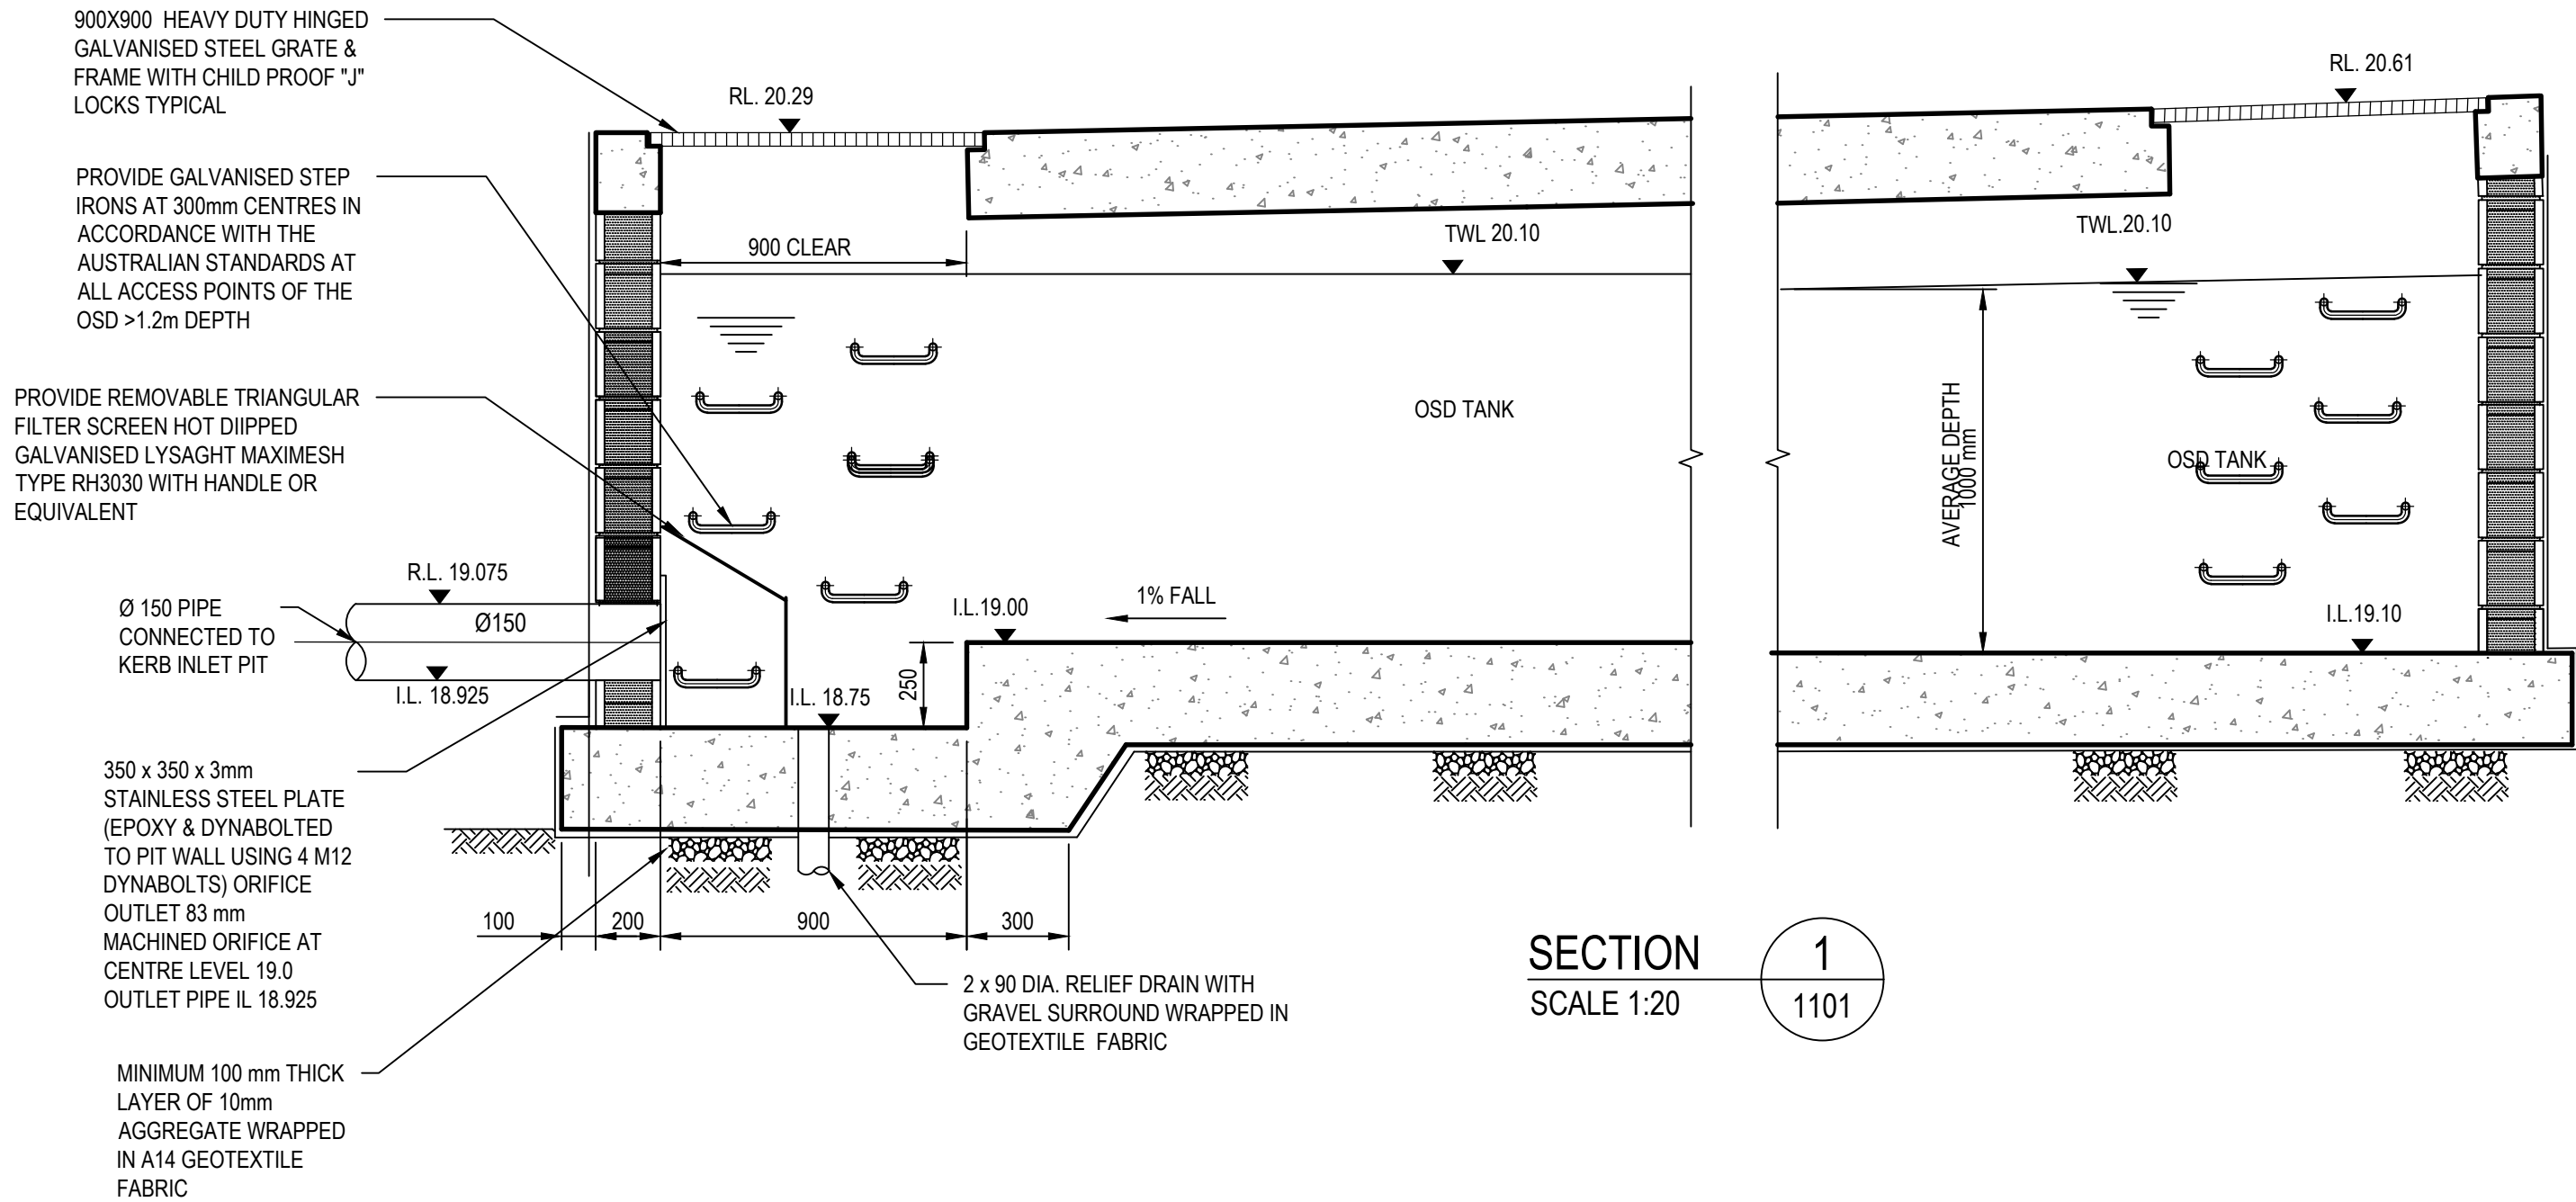
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Checked K.P.	Date FEB' 2022	Project PROPOSED DEVELOPMENT AT 47-49 CURRY STREET WALLSEND 2287
Designed K.P.	Date FEB' 2022	Title STORMWATER DETAILS SHEET 2
Verified C.F.	Date FEB' 2022	
Approved		

Status FOR APPROVAL NOT TO BE USED FOR CONSTRUCTION PURPOSES	Datum AHD	Scale AS SHOWN	Size A1
Drawing Number 80822047-CI-2102	Revision 5		




DATE PLOTTED: 28 November 2022 2:01 PM BY: ROCCO LARA



ORIFICE DIAMETER TO BE ENGRAVED ON THE PLATE SURFACE. ORIFICE TO BE EPOXY SEALED AROUND OUTER EDGES.


ORIFICE PLATE DETAIL

N.T.S.

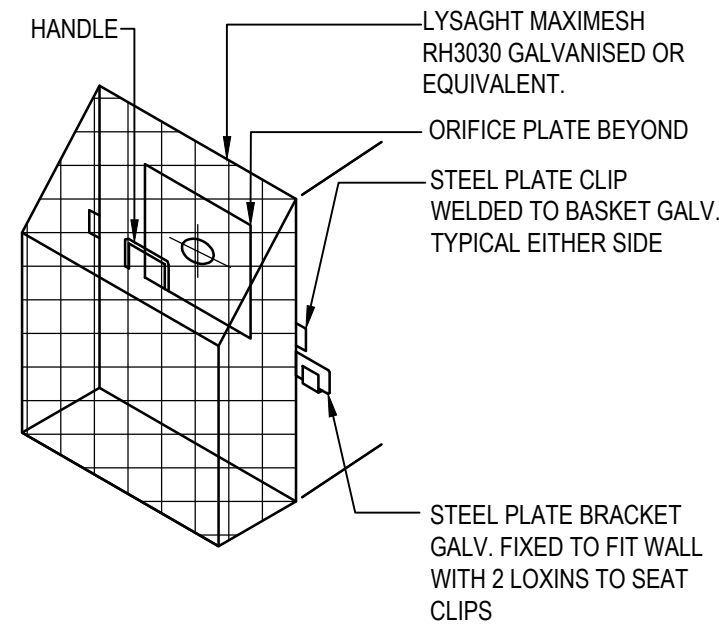

TRASH SCREEN DETAIL


N.T.S.

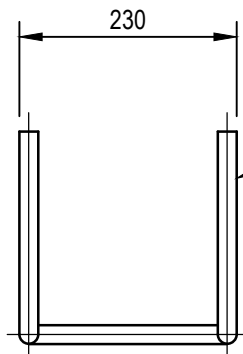

PLAN



FRONT ELEVATION

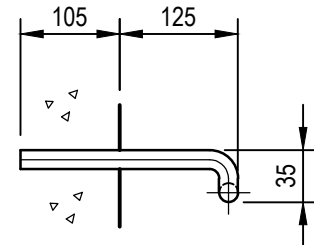

SIDE ELEVATION



STEP IRON DETAIL

N.T.S.

OSD SYSTEM DESIGN PARAMETER

AS PER THE NEWCASTLE CITY COUNCIL SECTION 7.06 STORMWATER GUIDELINES, DCP.

SITE AREA = 1226 m<sup>2</sup>  
IMPERVIOUSNESS RATE = 68.3%  
RAINFALL DEPTH = 16.7mm  
OSD REQUIRED = 1226 x 0.683 x 16.7 = 13.9m<sup>3</sup>  
OSD STORAGE PROVIDED = 15.5 m<sup>3</sup>  
OSD TANK DETAIL  
TOP WATER LEVEL = 20.10  
DEPTH OF WATER = 1.0m  
TANK AREA = 15.5m<sup>2</sup>  
ORIFICE DIAMETER = 83 mm

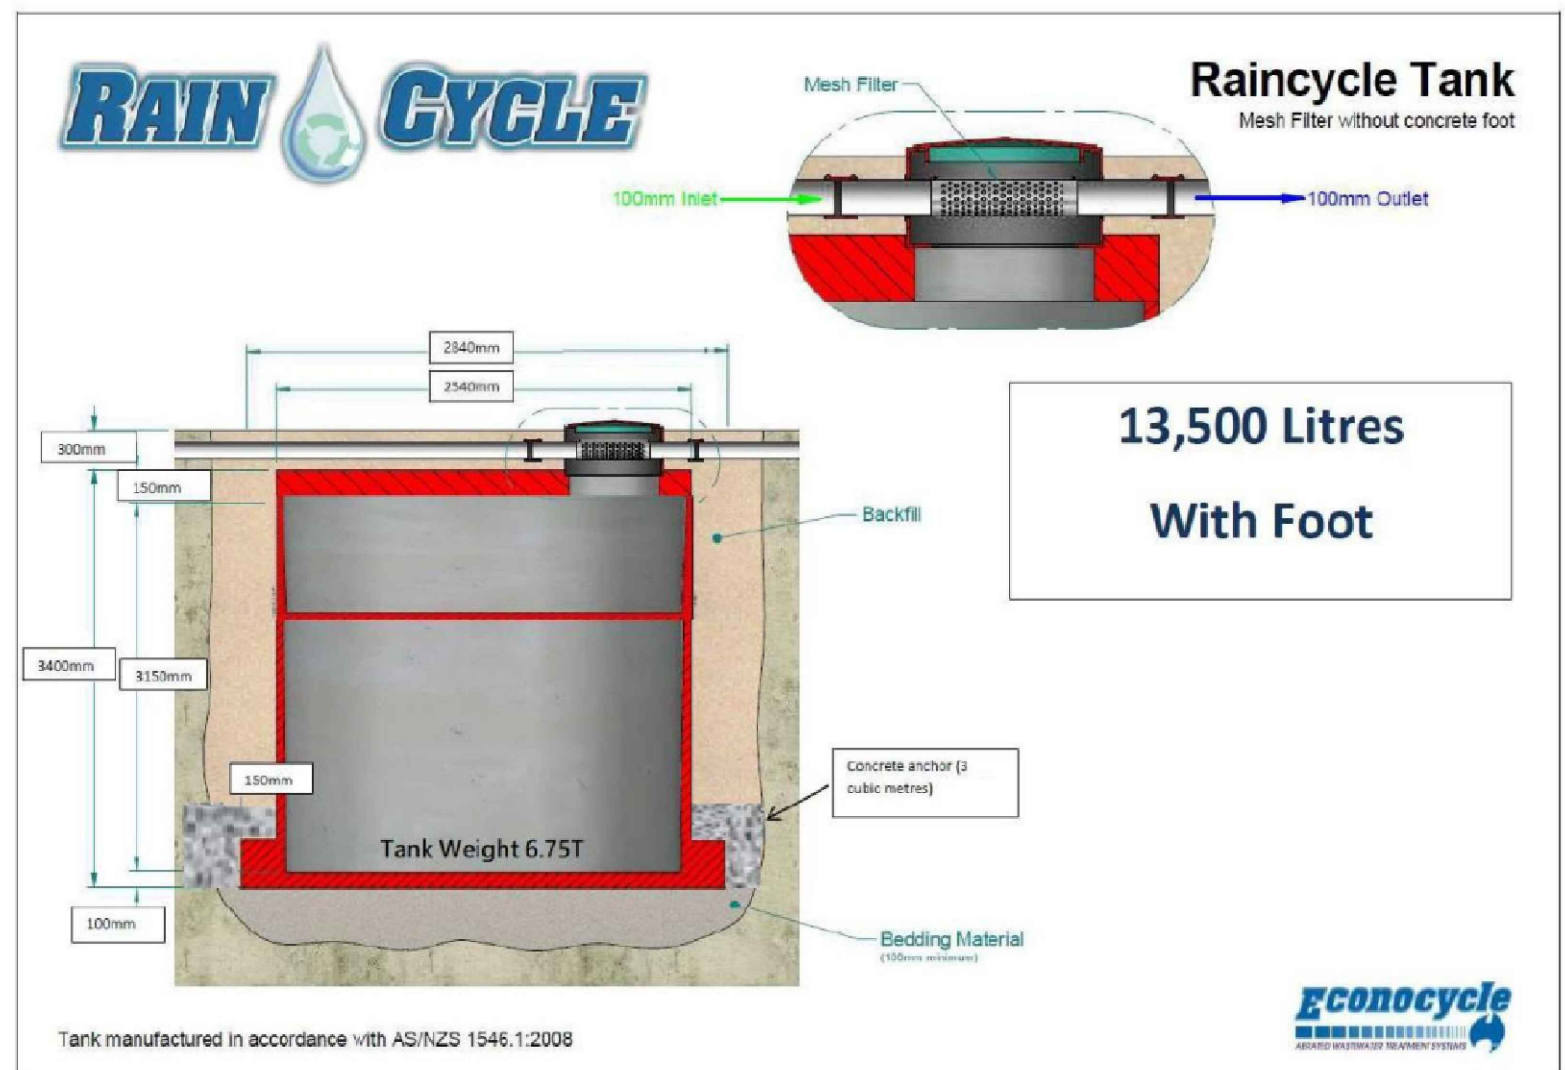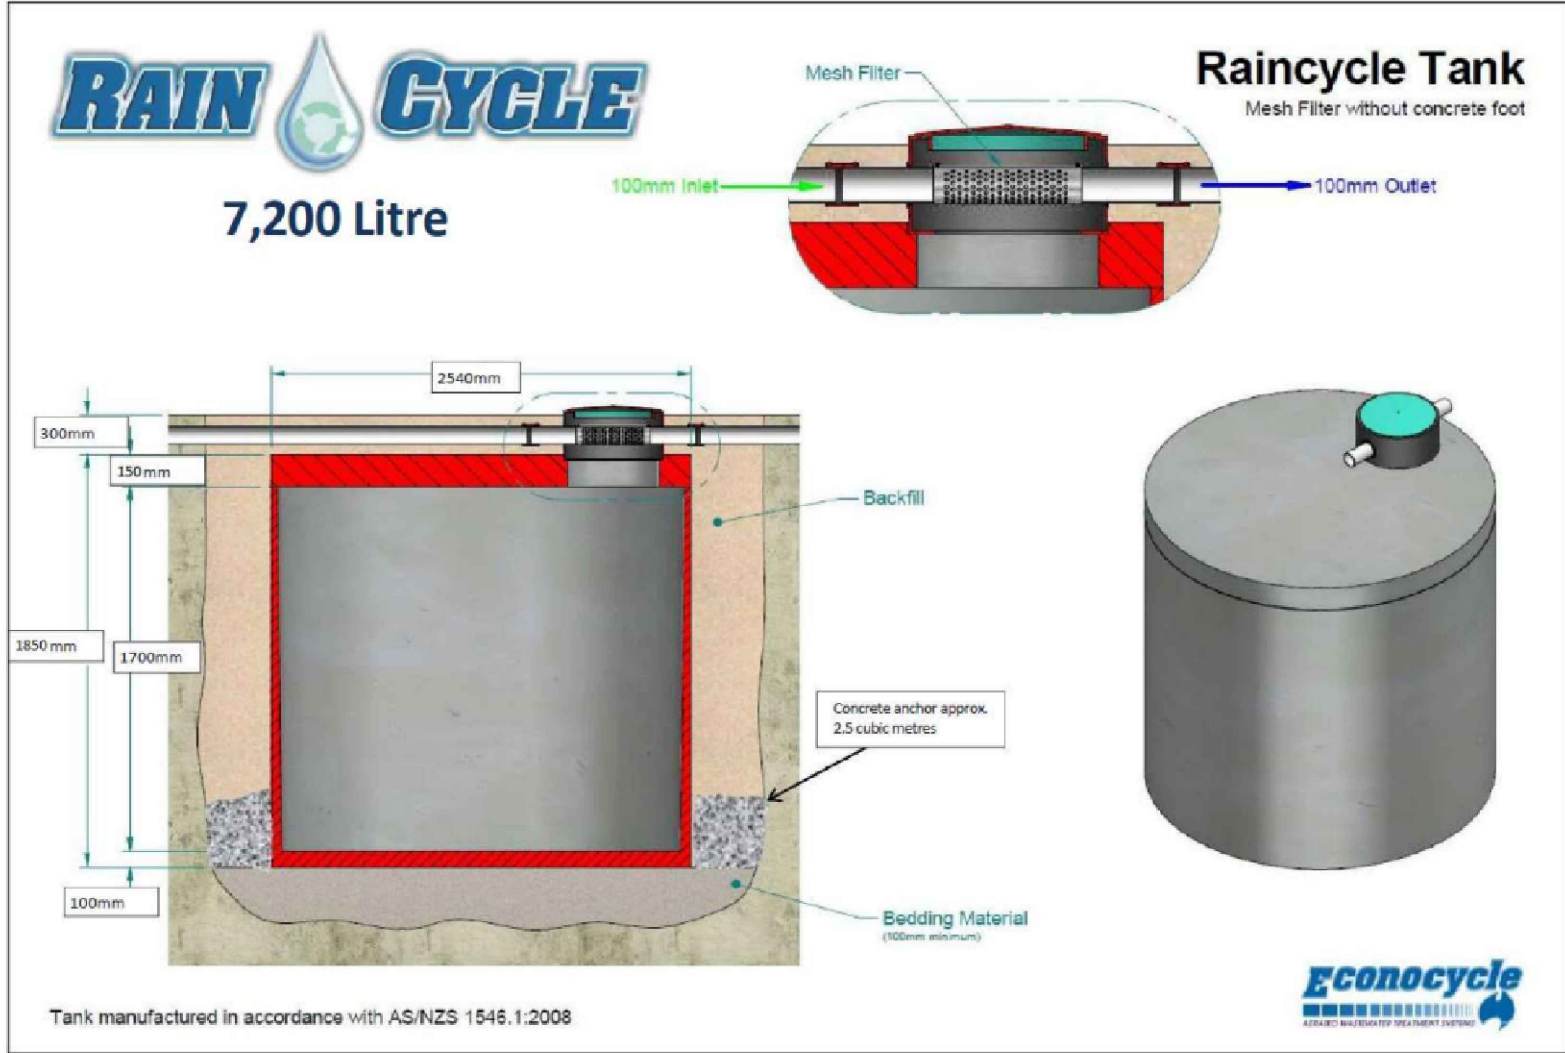

RAINWATER TANK NOTES

- RAINWATER TANK DIMENSIONS BASED ON PRODUCT SPECIFICATIONS PROVIDED BY RAINCYCLE. APPROVED EQUIVALENT TO BE NOMINATED IN DETAILED DESIGN STAGE SUBJECT TO STRUCTURAL REQUIREMENTS, MODEL AVAILABILITY, SITE CONSTRAINTS OR CONTRACTOR'S PREFERENCE.
- UNDERGROUND WATER TANK TO BE SITUATED AT LEAST 6m OFF EXISTING NEIGHBOURING DWELLINGS. STRUCTURAL IMPACT OF THE RAINWATER TANK PLACEMENT TOWARDS PROPOSED RESIDENTIAL BUILDING TO BE INVESTIGATED IN DETAILED DESIGN STAGE.
- CEILING AND MANHOLE OF WATER TANK TO BE STRUCTURALLY DESIGNED UNDER TRAFFIC LOADING.
- PROVIDE DRAWDOWN TO LOWER 50% VOLUME OF EACH RAINWATER TANK BY RETICULATION INTO EACH OF THE FOLLOWING NEW USES: SITE IRRIGATION SYSTEMS, EXTERNAL TAPS, ALL TOILETS, COLD WATER WASHING MACHINE TAPS AND LAUNDRY BASIN TAPS.
- THE UPPER REMAINING CAPACITY OF EACH RAINWATER TANK IS TO DRAIN FROM THE TANK BY WAY OF A 5mm WEEP HOLE CONNECTED TO THE MAIN OVERFLOW PIPE FOR THE TANK.
- MAINTAIN MINIMUM WATER DEPTH OF 100mm WITHIN ANY TANK.
- DETAILS OF ROOF WATER HARVESTING AND RETICULATION SYSTEM TO BE PROVIDED BY HYDRAULIC ENGINEER IN DETAILED DESIGN STAGE, IN ACCORDANCE WITH AUSTRALIAN STANDARDS, BCA, NCC AND COUNCIL STORMWATER GUIDELINES.

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Drawn K.P. Date FEB' 2022  
Checked K.P. Date FEB' 2022  
Designed K.P. Date FEB' 2022  
Verified C.F. Date FEB' 2022  
Approved

Client LAHC & SAMCRAWFORD ARCHITECTS

Project PROPOSED DEVELOPMENT AT  
47-49 CURRY STREET  
WALLSEND 2287

Title STORMWATER DETAILS  
SHEET 3  
OSD RAINWATER TANK DETAILS

Status **FOR APPROVAL**  
NOT TO BE USED FOR CONSTRUCTION PURPOSES

Datum AHD Scale AS SHOWN Size A1







Drawing Number 80822047-CI-2103 Revision 5

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DATE PLOTTED: 28 November 2022 2:01 PM BY: ROCCO LARA

XREFs: CAD File: \\cardno\cpg\global\NSW\Drawings\Structure\Projects\80822047-47-49 Curry Street Wallsend\012\_CIVIL\Drawings\Build\80822047-CI-2201.dwg



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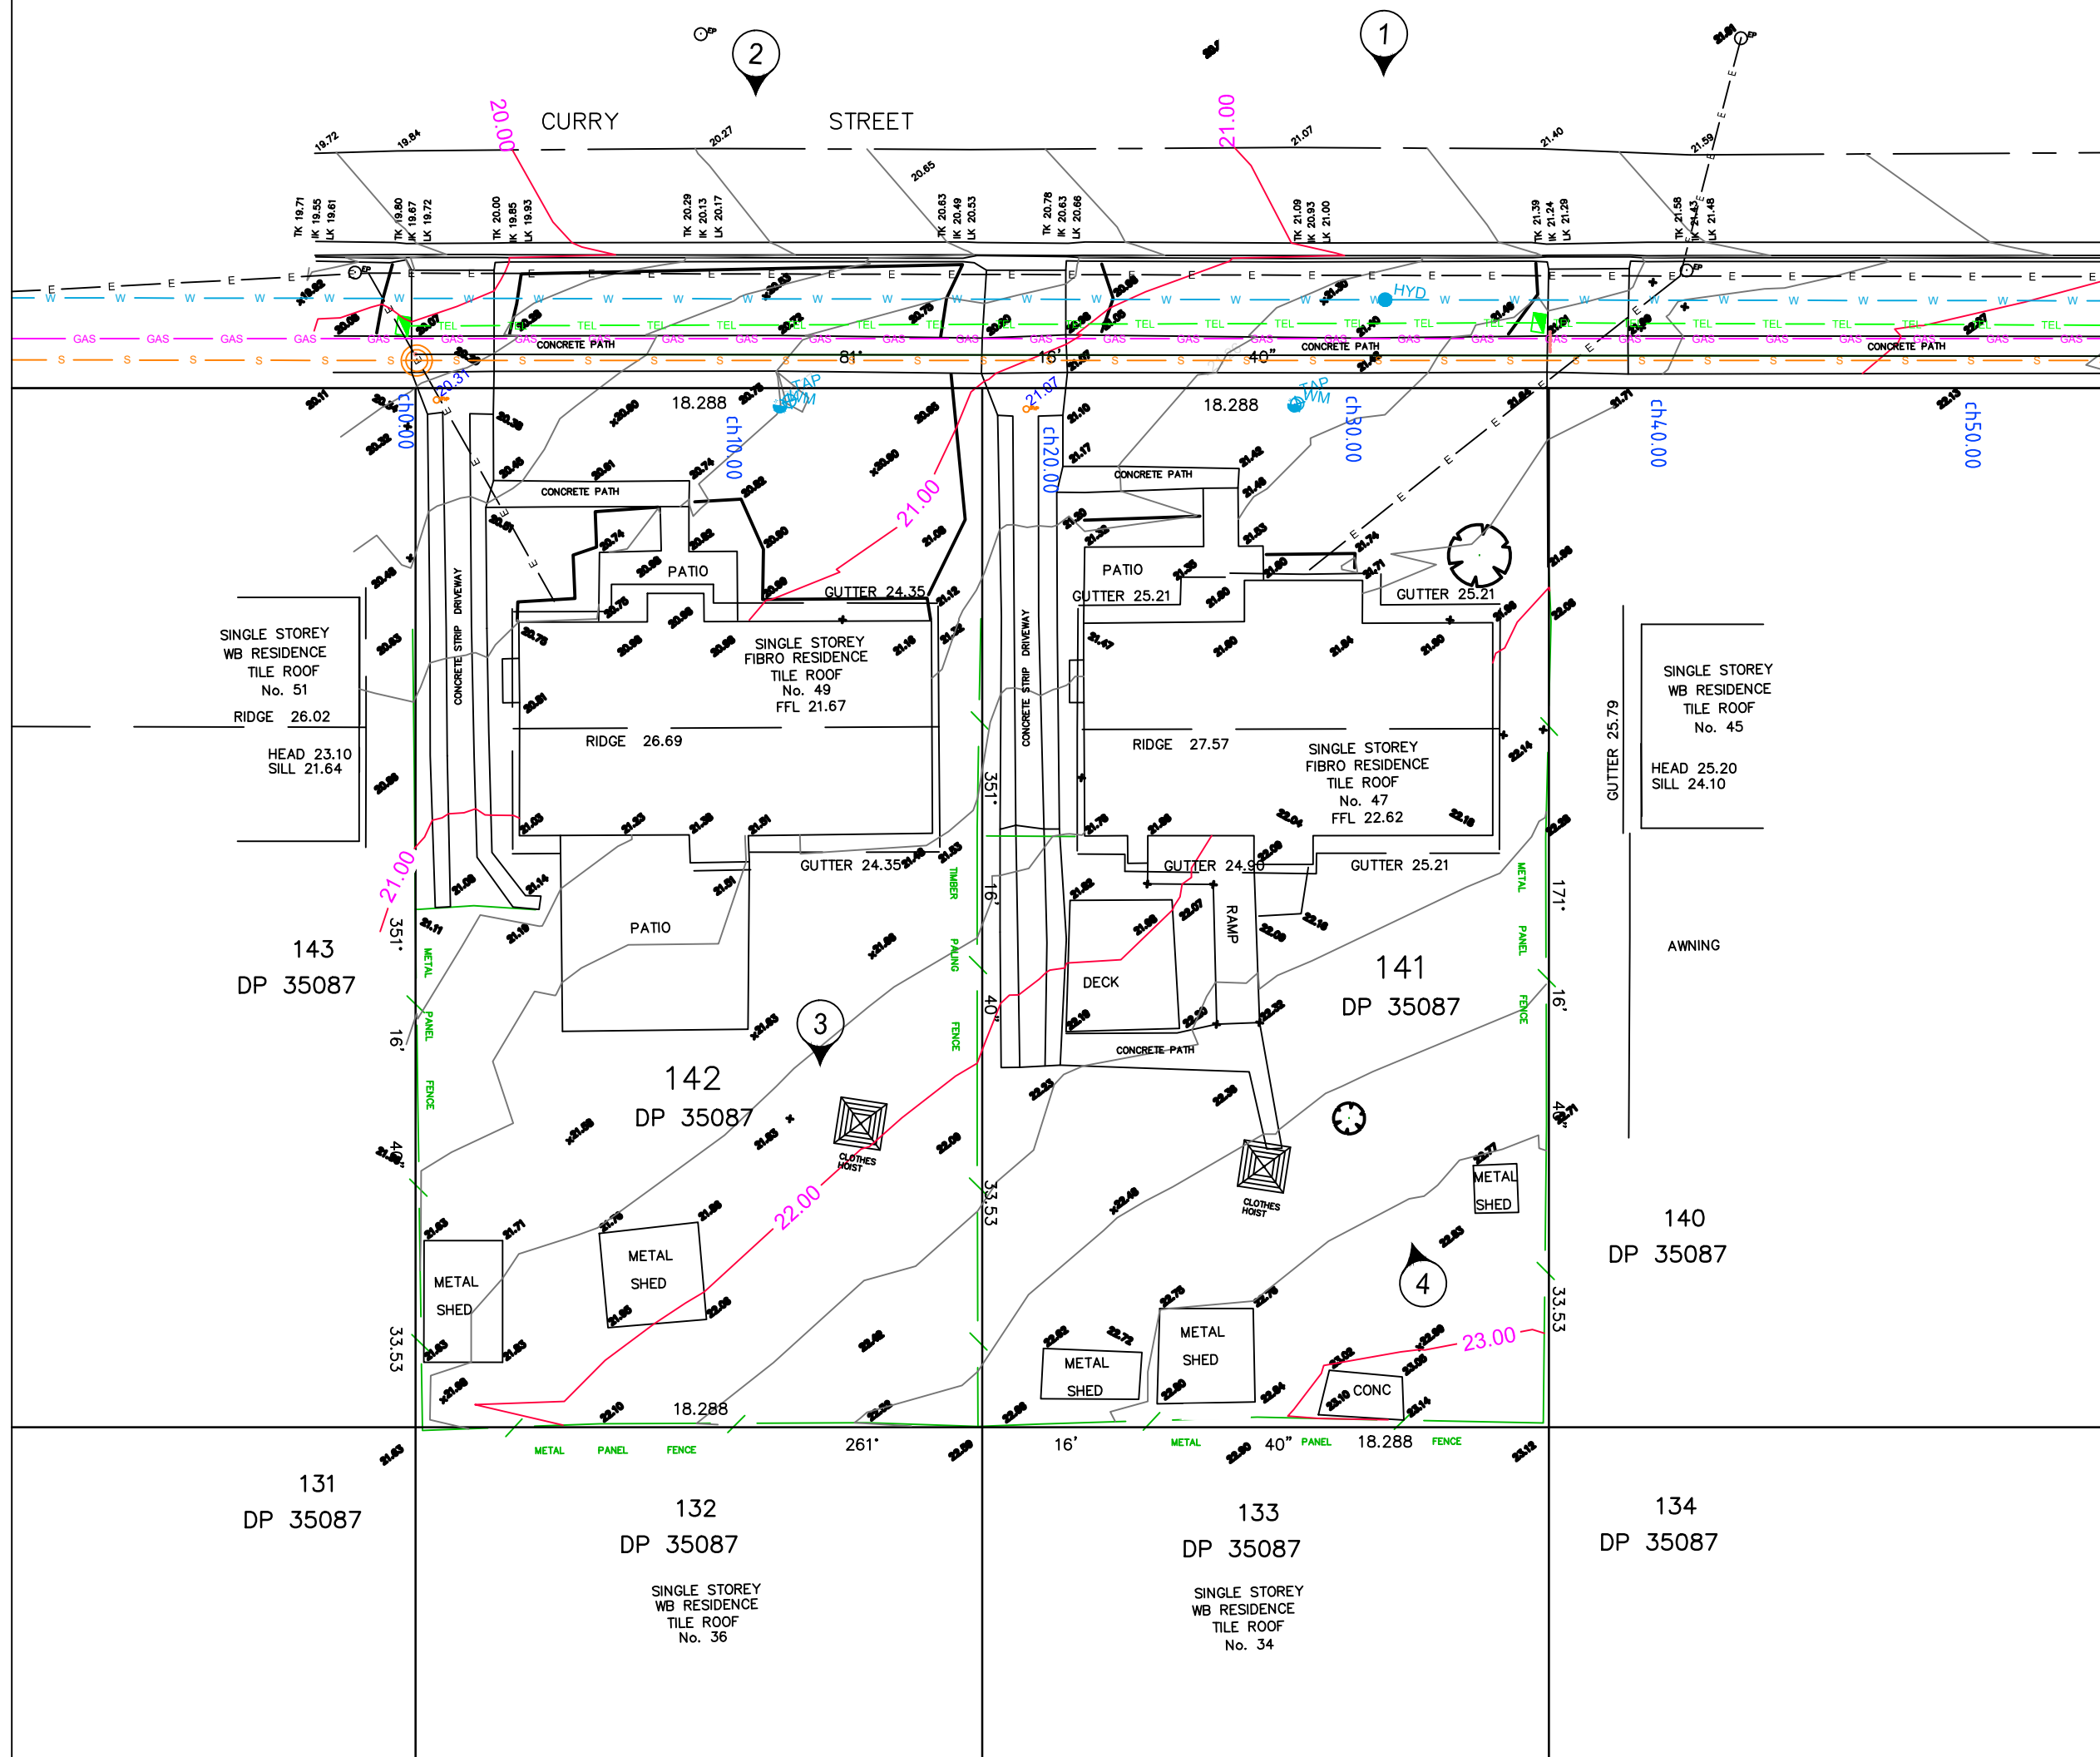
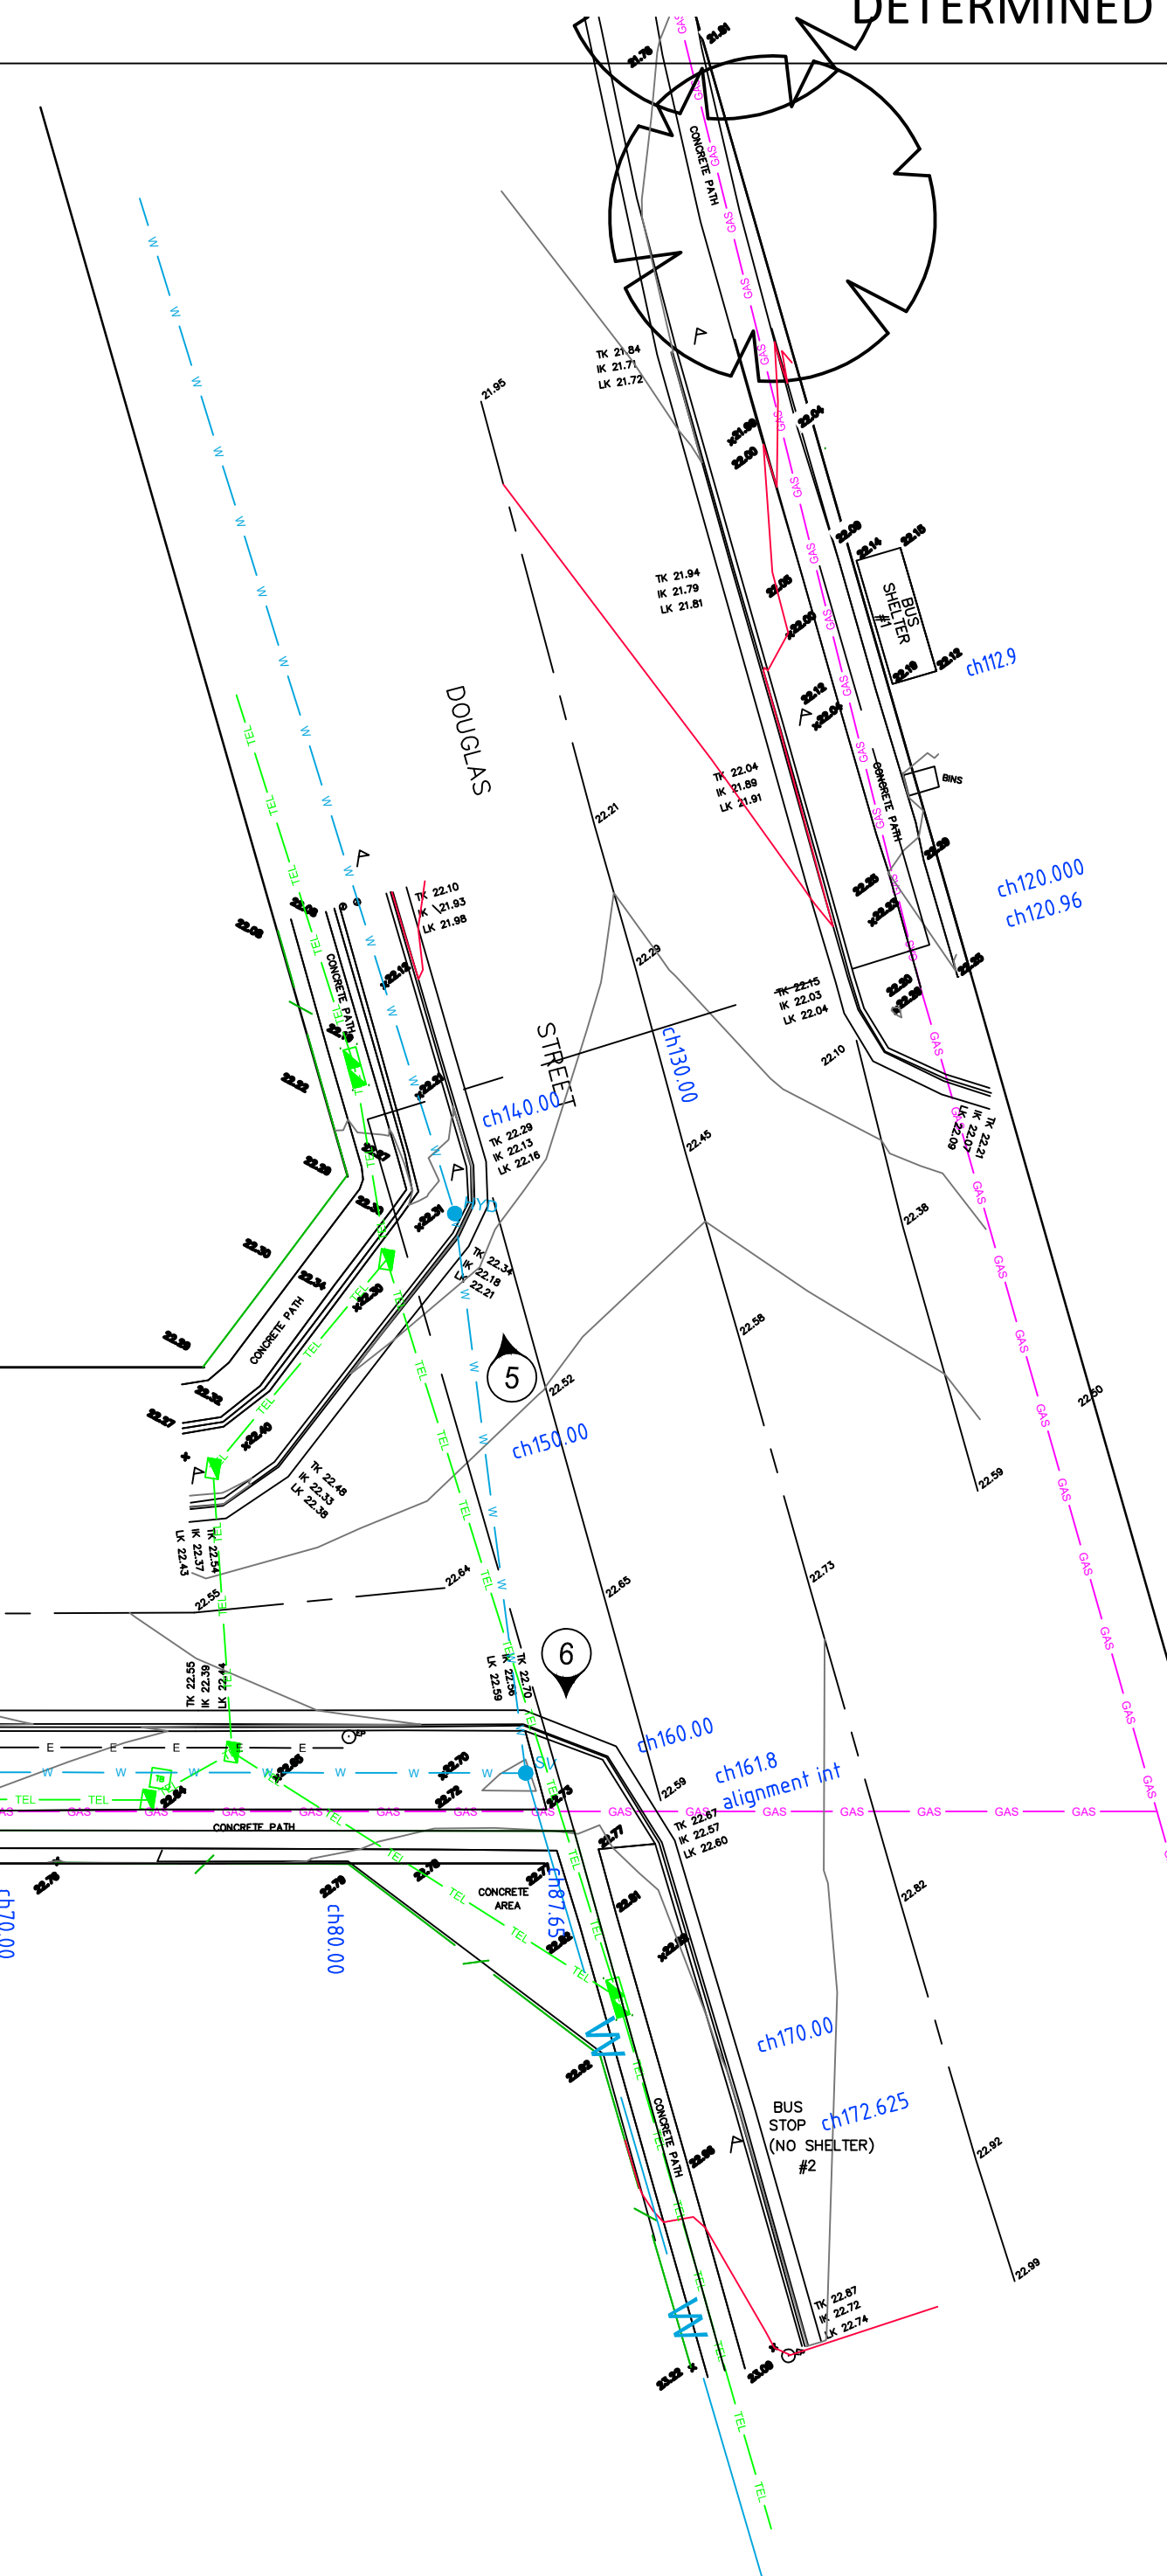
Drawn K.P. Date FEB' 2022  
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Verified C.F. Date FEB' 2022  
Approved

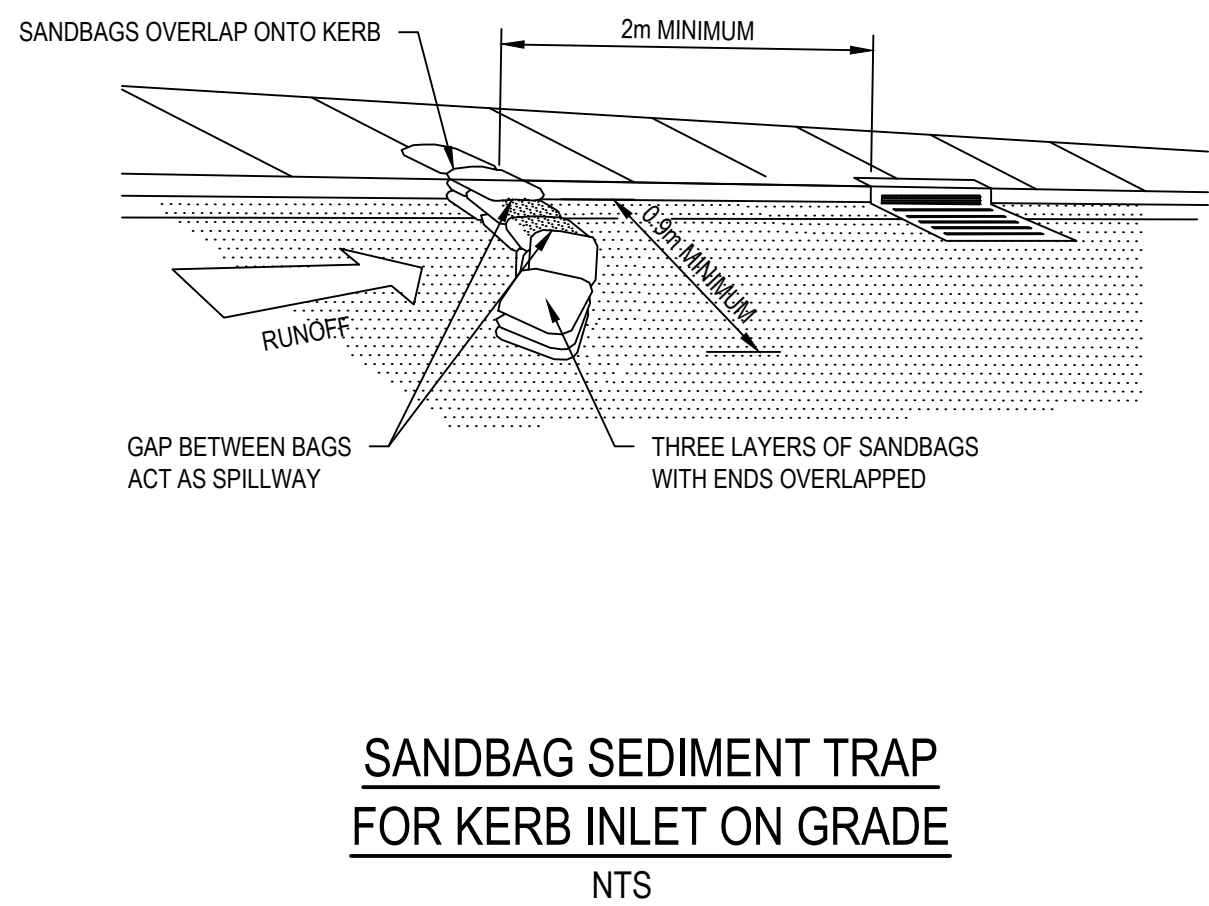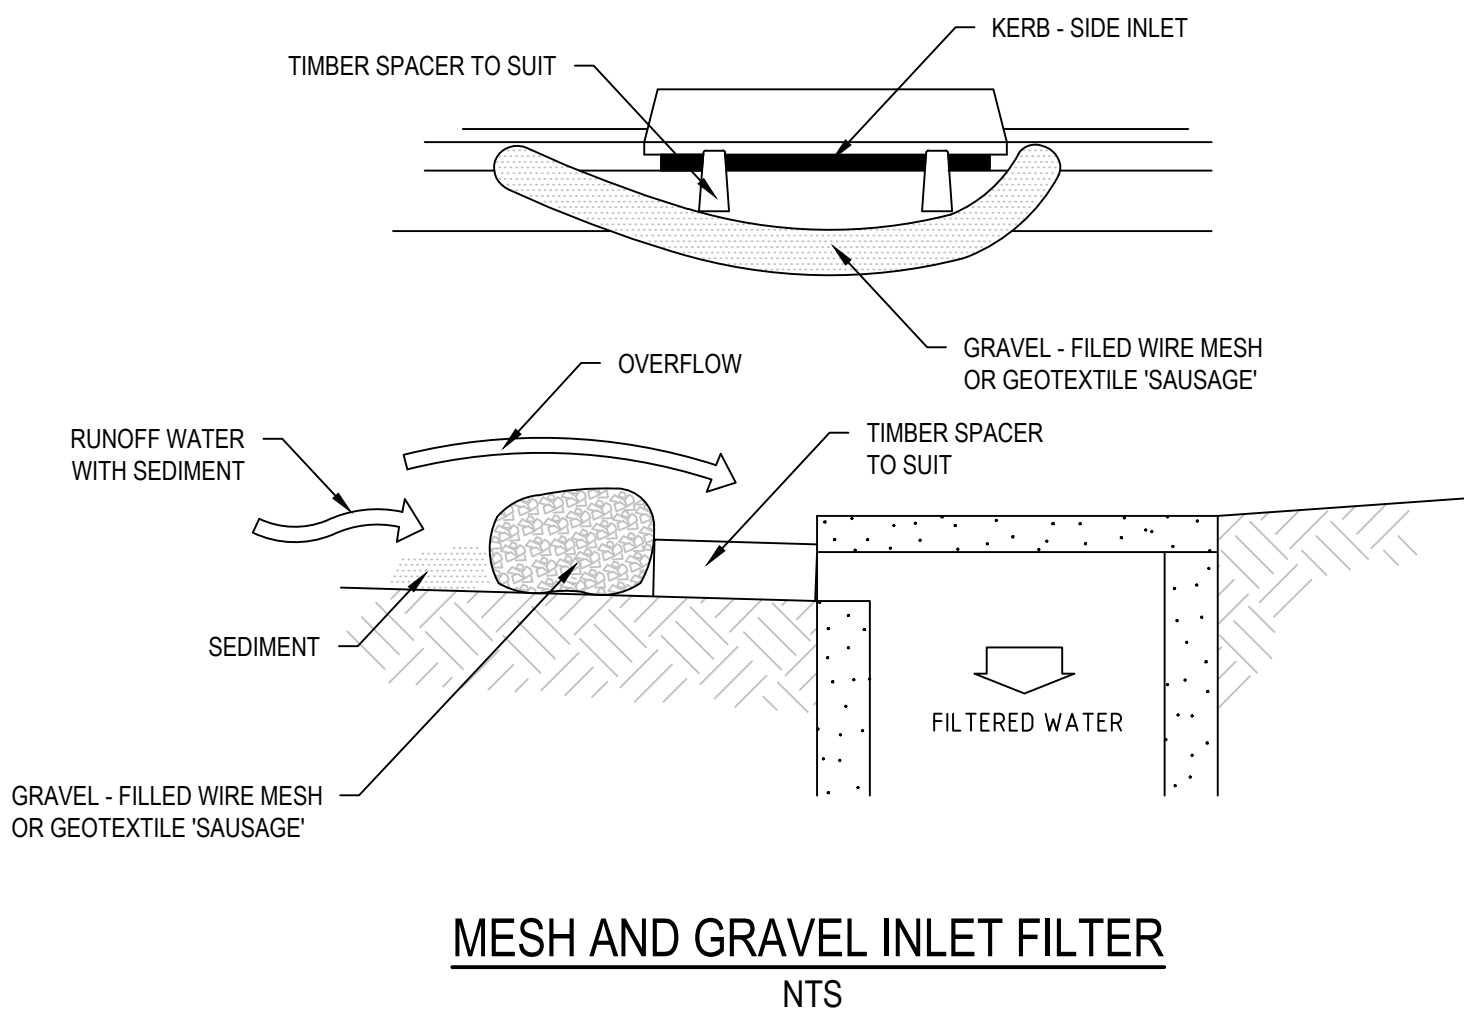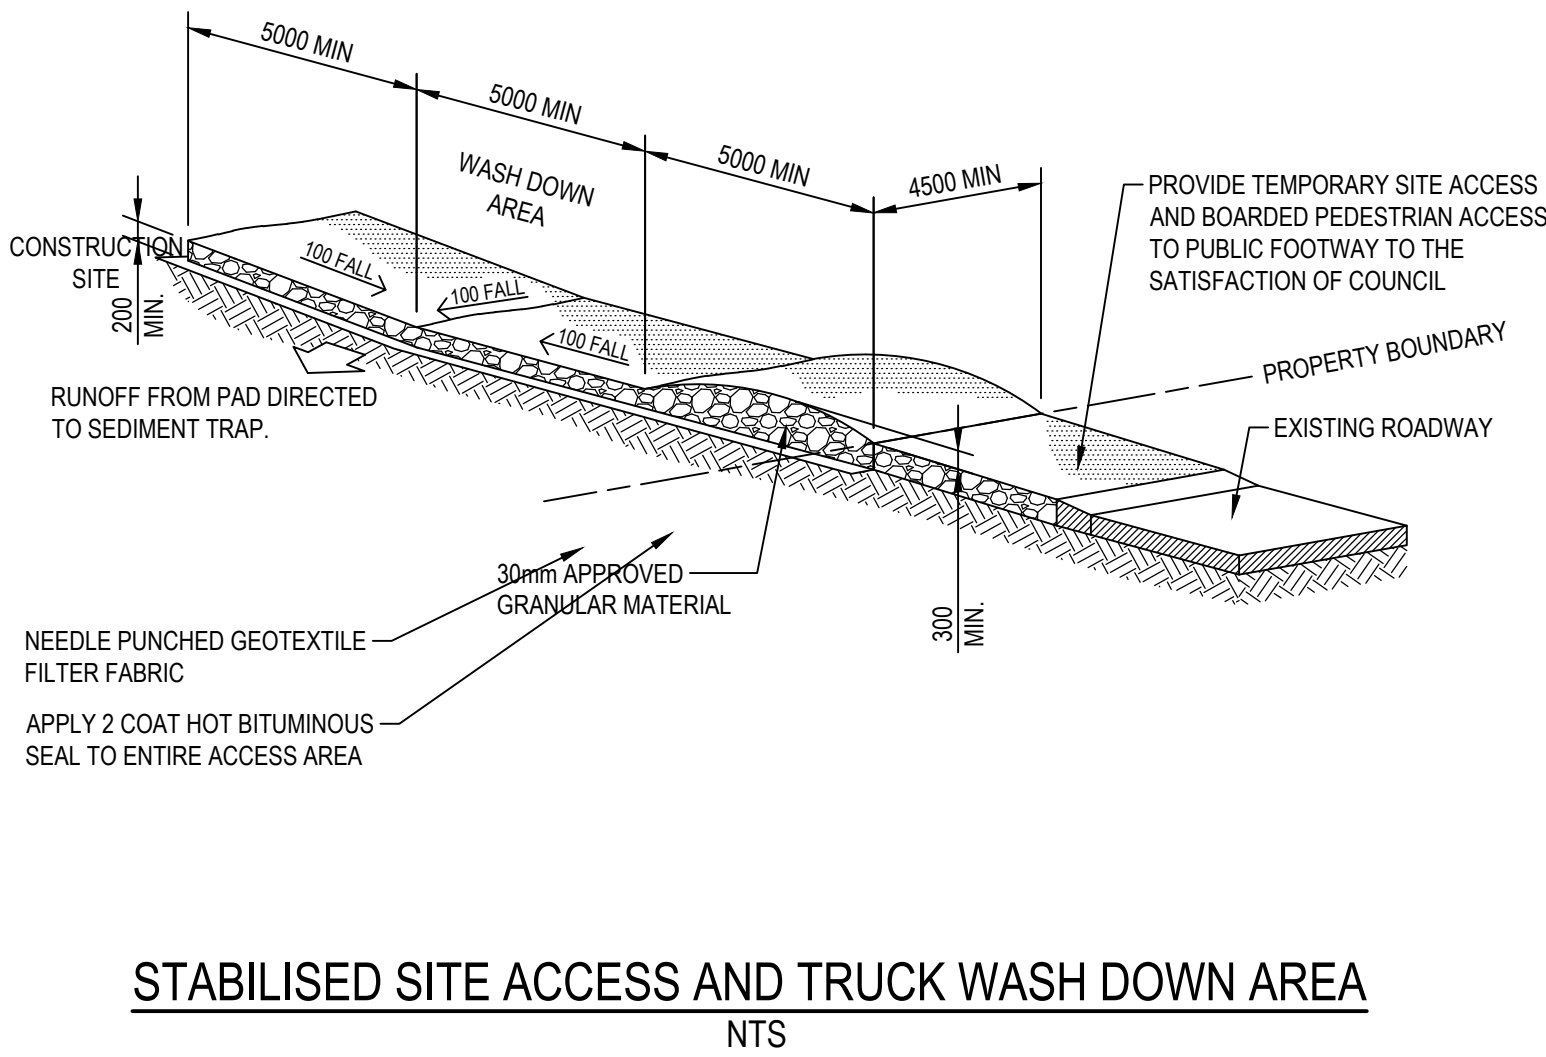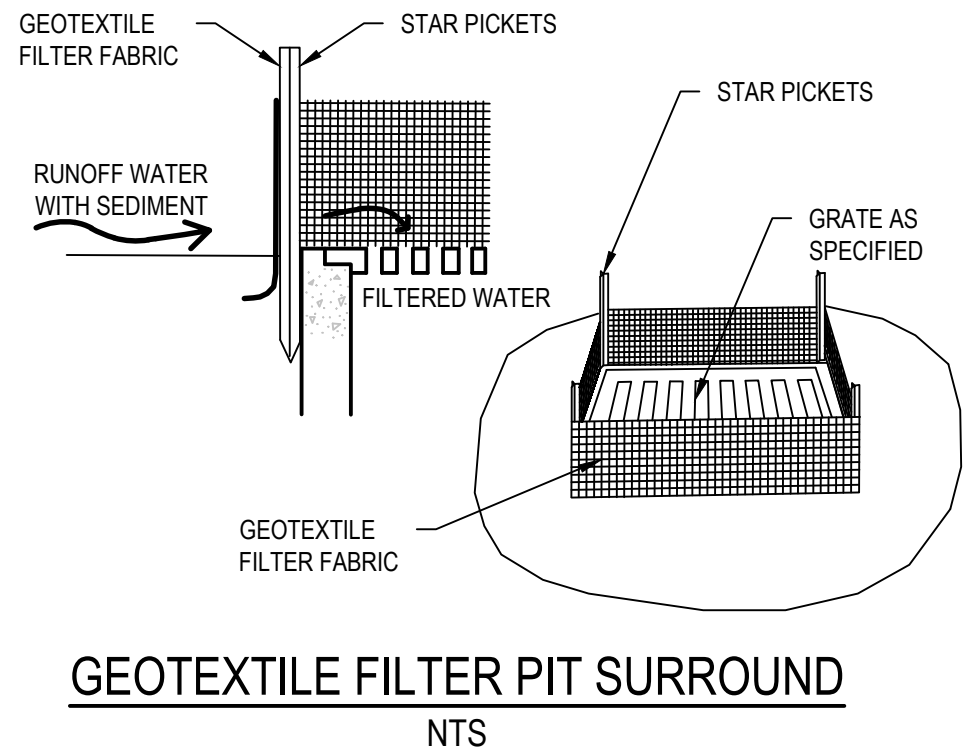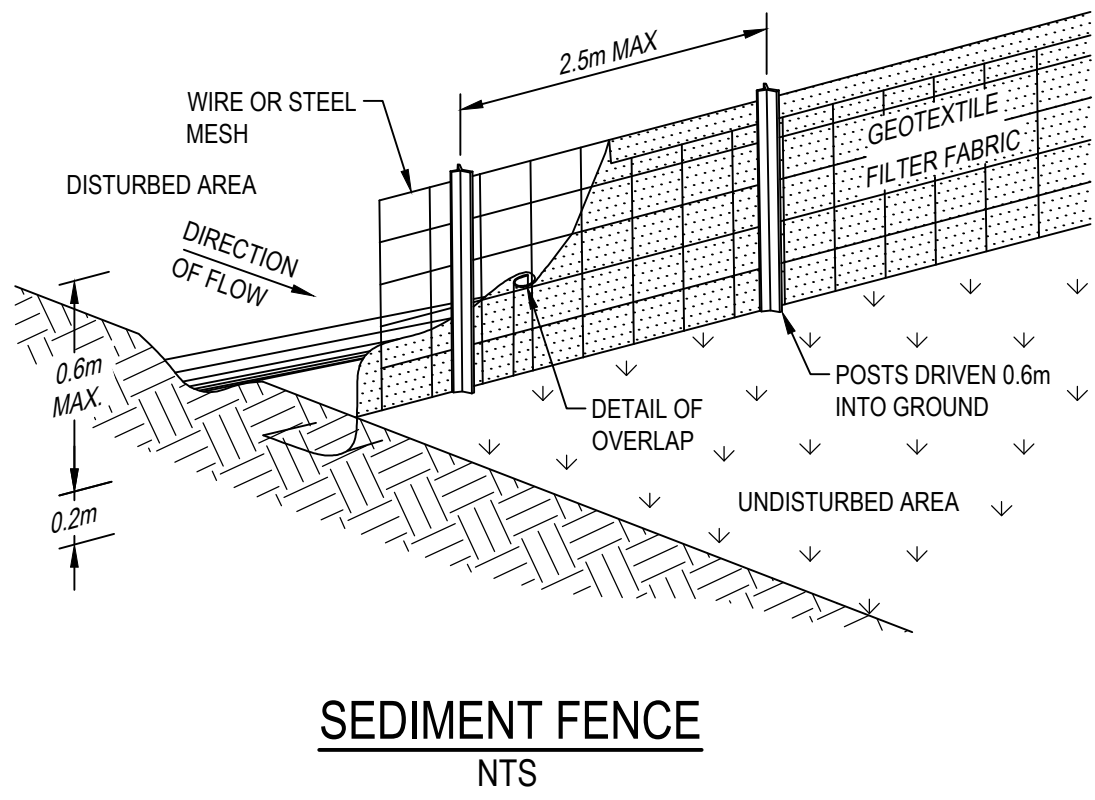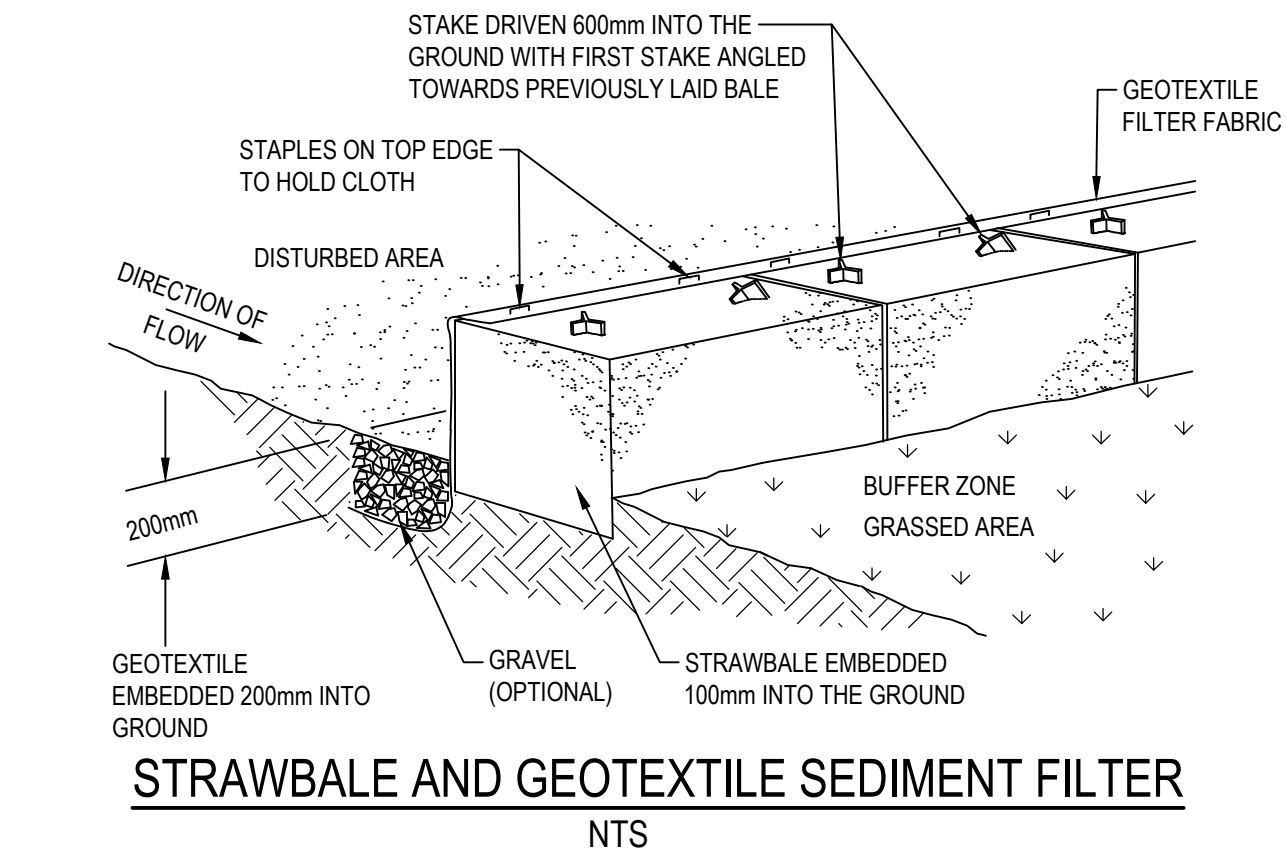Client LAHC & SAMCRAWFORD ARCHITECTS  
Project PROPOSED DEVELOPMENT AT  
47-49 CURRY STREET  
WALLSEND 2287  
Title SEDIMENTATION AND EROSION CONTROL  
DETAILS

Status **FOR APPROVAL**  
NOT TO BE USED FOR CONSTRUCTION PURPOSES  
Datum AHD Scale AS SHOWN Size A1  
Drawing Number 80822047-CI-2201 Revision 5

Rev.	Date	Description	Des.	Verif.	Appd.
5	28/11/2022	REVISED ISSUE FOR DA APPROVAL	A.L.	P.L.	M.R.
4	1/06/2022	REVISED ISSUE	K.P.	C.F.	
3	4/04/2022	REVISED ISSUE FOR DA APPROVAL	K.P.	C.F.	
2	7/03/2022	ISSUE FOR DA APPROVAL	K.P.	C.F.	
1	10/02/2021	PRELIMINARY ISSUE	K.P.	K.P.	C.F.





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|-----|----------|--------------------|--------------------------------------|------|--------------------|--|--|---|--|---|---|--|
| No. | DATE     | NOTATION/AMENDMENT | No.                                  | DATE | NOTATION/AMENDMENT | CONTOUR INTERVAL: 0.25m<br>DATUM: AHD<br>ORIGIN OF DATUM: PM 18017<br><br>100 YEAR FLOOD RL:<br>RECOMMENDED MINIMUM FLOOR RL:<br><br>SOURCE OF FLOOD INFO: |  | REDUCTION RATIO 1 : .....200.....<br><br>LAND TITLE INFORMATION<br><br>LOTS: 141, 142<br>PLAN NOS : DP 35087<br><br>OTHER:<br>Lot 141: Conversion 607m², Calculates 613m²<br>Lot 142: Conversion 607m², Calculates 613m²<br>AREA: | DATE OF SURVEY: 10 / 11 / 2018<br>SURVEY CONSULTANT:<br><br>RPS Australia East<br><br>SURVEYORS .....<br>REF: 118791-276 Registered Surveyor | <br>Division of the Department of Family & Community Services<br><br>DRAWING TITLE<br><br>Detail Survey | LOCATION<br><br>WALLSEND<br><br>STREET ADDRESS<br><br>47-49 CURRY STREET<br><br>TYPE<br><br>S<br><br>SITE LAYOUT JOB<br>/ /<br>SHT. 1<br>OF 1 |  |
| 1   | 12-04-19 | amend lot areas    |                                      |      |                    |  |  |   |  |   |   |  |
|     |          |                    | FILE<br>FILE SIZE (MB)<br>CHECKED BY |      |                    |  |  |   |  |   |   |  |